

HOWARD COUNTY DEPARTMENT OF PUBLIC WORKS

9250 Bendix Road

Columbia, Maryland 21045

410-313-2414

Thomas E. Butler, P.E., Deputy Director of Public Works Engineering, Development and Construction www.howardcountymd.gov

FAX 410-313-6144 TDD 410-313-2323

AS-BUILT / ORIGINAL

DRAWINGS TO BE

SCANNED

DATE: APRIL 18, 2019

Bureau of Engineering, T&SP 9250 Bendix Road, Columbia, MD 21045 Ph. (410) 313-6143 Fax (410) 313-6141 name@howardcountymd.gov

TO

⊠Plans

□USPS

Via:

Sheila Convery

Prints

□Fed Ex

We are sending the following:

Transportation and Special Projects Division

□ Specs

□ UPS

	CAP.	PROJECT NO.	PROJECT NAME		
N-3107		07	Rockburn Branch Park Maintenance Facility		
ITE	EM NO.		DESCRIPTION	QUANTITY	
			ne attached as-built/ Original construction drawings added to the interactive map.	1 set	

☐Shop dwgs

☐ Courier

Other

Other


Kind Regards,

Abeye Girma

INDEX OF SHEETS

DESCRIPTION SHEET NO. TITLE SHEET C-I - OVERALL SITE PLAN C-2 - GEOMETRIC LAYOUT C-3 - SITE AND GRADING PLAN C-4 - HANDICAP PARKING DETAILS C-5 - TYPICAL ROADWAY SECTIONS AND MISCELLANEOUS DETAILS C-5A - SITE DETAILS I C-5B - SITE DETAILS 2 C-6 - ROADWAY PROFILES C-8 - WATER AND SEWER PLAN C-8A - SITE UTILITY PLAN C-8B - SITE UTILITY PROFILE AND DETAILS C-I5 - EROSION AND SEDIMENT CONTROL PLAN C-16 - EROSION AND SEDIMENT CONTROL DETAILS I C-18 - PAVEMENT ELEVATIONS C-19 - HOWARD COUNTY STANDARD DETAILS BUILDING 'A' PLANS ARCHITECTURAL PLANS A-I - FLOOR PLAN & INTERIOR ELEVATIONS A-2 - ROOF PLAN & ELEVATIONS A-3 - WALL SECTIONS & DETAILS A-4 - REFLECTED CEILING PLAN & WALL SECTIONS A-5 - SCHEDULES & DETAILS A-6 - DATA SHEET STRUCTURAL PLANS 23 S-I - FOUNDATION PLAN, SECTIONS AND DETAILS S-2 - SECTIONS AND DETAILS S-3 - STRUCTURAL NOTES MECHANICAL PLANS M-I - FLOOR PLAN MECHANICAL 26 M-2 - MECHANICAL SCHEDULE M-3 - MECHANICAL SPECIFICATIONS & DETAILS 28 PLUMBING PLANS P-I - FLOOR PLAN PLUMBING P-2 - PLUMBING SCHEDULE P-3 - PLUMBING DETAILS P-4 - PLUMBING SPECIFICATIONS ELECTRICAL PLANS E-O - SITE PLAN ELECTRICAL E-I - FLOOR PLAN POWER E-2 - FLOOR PLAN LIGHTING F-3 - POWER DISTRIBUTION DIAGRAMS E-4 - SYMBOL LEGEND AND SPECIFICATIONS E-5 - PANELBOARD SCHEDULES

DRAWINGS C-7, C-9, C-10, C-11, C-12, C-13, C-14, AND C-17 ARE NOT INCLUDED AS PART OF THE PLAN SET.

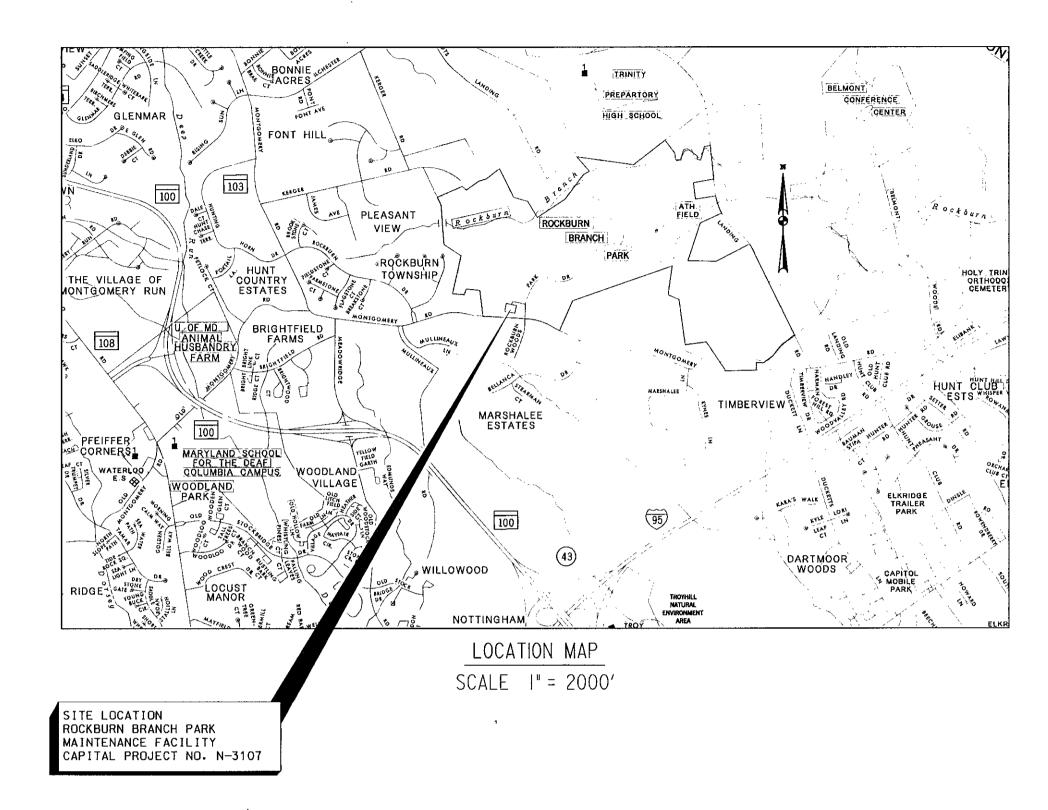

CAPITAL PROJECT NO. N-3107

ROCKBURN BRANCH PARK MAINTENANCE FACILITY

HOWARD COUNTY, MARYLAND DEPARTMENT OF PUBLIC WORKS


GENERAL NOTES

- ALL INFORMATION AND DETAILS ON THESE DRAWINGS SHALL BE CONSTRUCTED AS PER THE PLANS OR AS DIRECTED BY THE HOWARD COUNTY ENGINEER.
- ALL STATIONING AND DIMENSIONING ARE TO BE FIELD VERIFIED BY THE CONTRACTOR.
- APPROXIMATE LOCATIONS OF EXISTING UTILITIES ARE SHOWN. THE CONTRACTOR SHALL TAKE ALL NECESSARY PRECAUTIONS TO PROTECT EXISTING UTILITIES AND TO MAINTAIN UNINTERRUPTED SERVICE. ANY DAMAGE INCURRED SHALL BE REPAIRED IMMEDIATELY TO THE SATISFACTION OF THE ENGINEER BY THE CONTRACTOR AT THE CONTRACTOR'S EXPENSE. THE CONTRACTOR SHALL NOTIFY THE FOLLOWING UTILITIES OR AGENCIES AT LEAST FIVE (5) DAYS BEFORE STARTING WORK SHOWN ON THESE PLANS.
 - AT&T 1-800-252-II33 COMCAST 410-461-1362
 - BGE (CONTRACTOR SERVICES) 410-850-4620
 - BGE (UNDERGROUND DAMAGE CONTROL) 410-787-9068 MISS UTILITY 1-800-257-7777

 - HOWARD COUNTY BUREAU OF UTILITIES 410-313-4900
 - HOWARD COUNTY DIVISION OF CONSTRUCTION INSPECTION 410-313-1880 VERIZON - TELECOMMUNICATIONS 1-800-743-0033 / 410-224-9210
 - THE CONTRACTOR SHALL CONTACT THE HOWARD COUNTY CONSTRUCTION INSPECTION DIVISION OF ENGINEERING FOR VERIFICATION AND/OR INFORMATION REGARDING:
 - A. PROPOSED/EXISTING RIGHT-OF-WAY
 - B. UTILITY RELOCATION
 - C. MAINTENANCE OF TRAFFIC DURING CONSTRUCTION
 - D. EROSION/SEDIMENT CONTROL CERTIFICATION AND PERMIT
 - E. HORIZONTAL/VERTICAL SURVEY CONTROL
 - F. GRADING PERMIT
- 4. SEE HOWARD COUNTY STANDARD DETAILS NO'S G-1.01 AND G-1.02 FOR STANDARD SYMBOLS.
- HORIZONTAL COORDINATES ARE BASED ON MD NAD 83/91 HORIZONTAL DATUM AND VERTICAL ELEVATIONS ARE BASED ON NAVD 1988 VERTICAL DATUM, TRANSFERRED FROM HOWARD COUNTY CONTROL STATIONS; 37BA AND 37BB.

37BA N 563,785.618 37BB N 563,663.415 E 1,376,343.172 E 1,378,040.471

- ELEV. 394.786 ELEV. 373.822
- 6. A STAGING AND STOCKPILE AREA WILL BE DETERMINED BY THE CONTRACTOR AND APPROVED BY THE HOWARD COUNTY ENGINEER.
- 7. SUPPLEMENTAL TOPOGRAPHY SURVEY INFORMATION BASED ON FIELD SURVEY PERFORMED BY JOHNSON, MIRMIRAN & THOMPSON DATED MAY, 2005 AND FEBRUARY, 2007.
- ORIGINAL TOPOGRAPHY SURVEY PREPARED BY PROGRESSIVE ENGINEERING CONSULTANTS, INC. DATED JULY 2000.
- 9. PROFESSIONAL ENGINEERS SEAL PROVIDED BY JOHNSON, MIRMIRAN & THOMPSON IS ONLY FOR REVISIONS TO THE PLANS ORGINALLY PREPARED AND SEALED BY OTHERS.
- 10. THESE PLANS REFLECT WORK THAT HAS ALREADY BEEN CONSTRUCTED AS WELL AS WORK TO BE CONSTRUCTED AS PART OF THIS IN THIS CONTRACT.

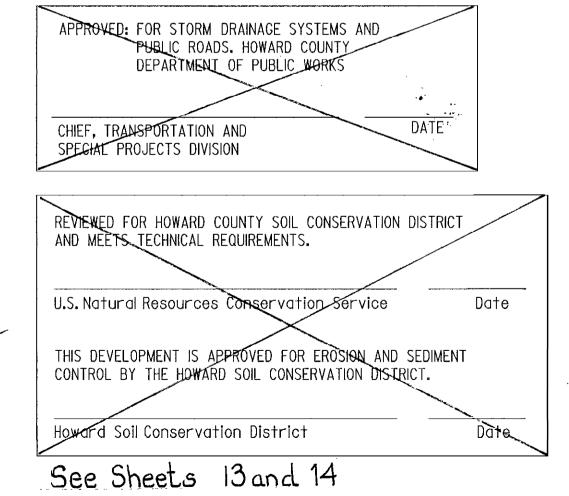

TITLE SHEET

DEPARTMENT OF PUBLIC WORKS

HOWARD COUNTY, MARYLAND Year M. V. 7/5/67

DIRECTOR OF PUBLIC WORKS

DATE

FULL DEPTH HMA PAVEMENT

HMA PAVEMENT GRIND, WEDGE/LEVEL, & OVERLAY


HMA PAVEMENT OVERLAY

CONCRETE SIDEWALK

HMA PAVEMENT WEDGE/LEVEL

DEPARTMENT OF PARKS AND RECREATION DIRECTOR OF DEPARTMENT OF PARKS AND RECREATION



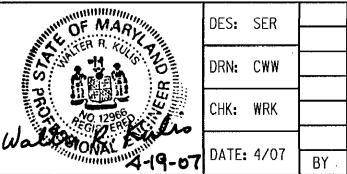

CAPITAL PROJECT NO. N - 3107

ROCKBURN BRANCH PARK MAINTENANCE FACILITY

SHEET <u>l</u> of <u>38</u>

SCALE


AS SHOWN


Steve Shavan 7/2/67 CHIEF, TRANSPORTATION AND SPECIAL PROJECTS DIVISION


PAVING LEGEND


& OVERLAY


CHIEF PHREAT OF HIGHWAYS DATE:

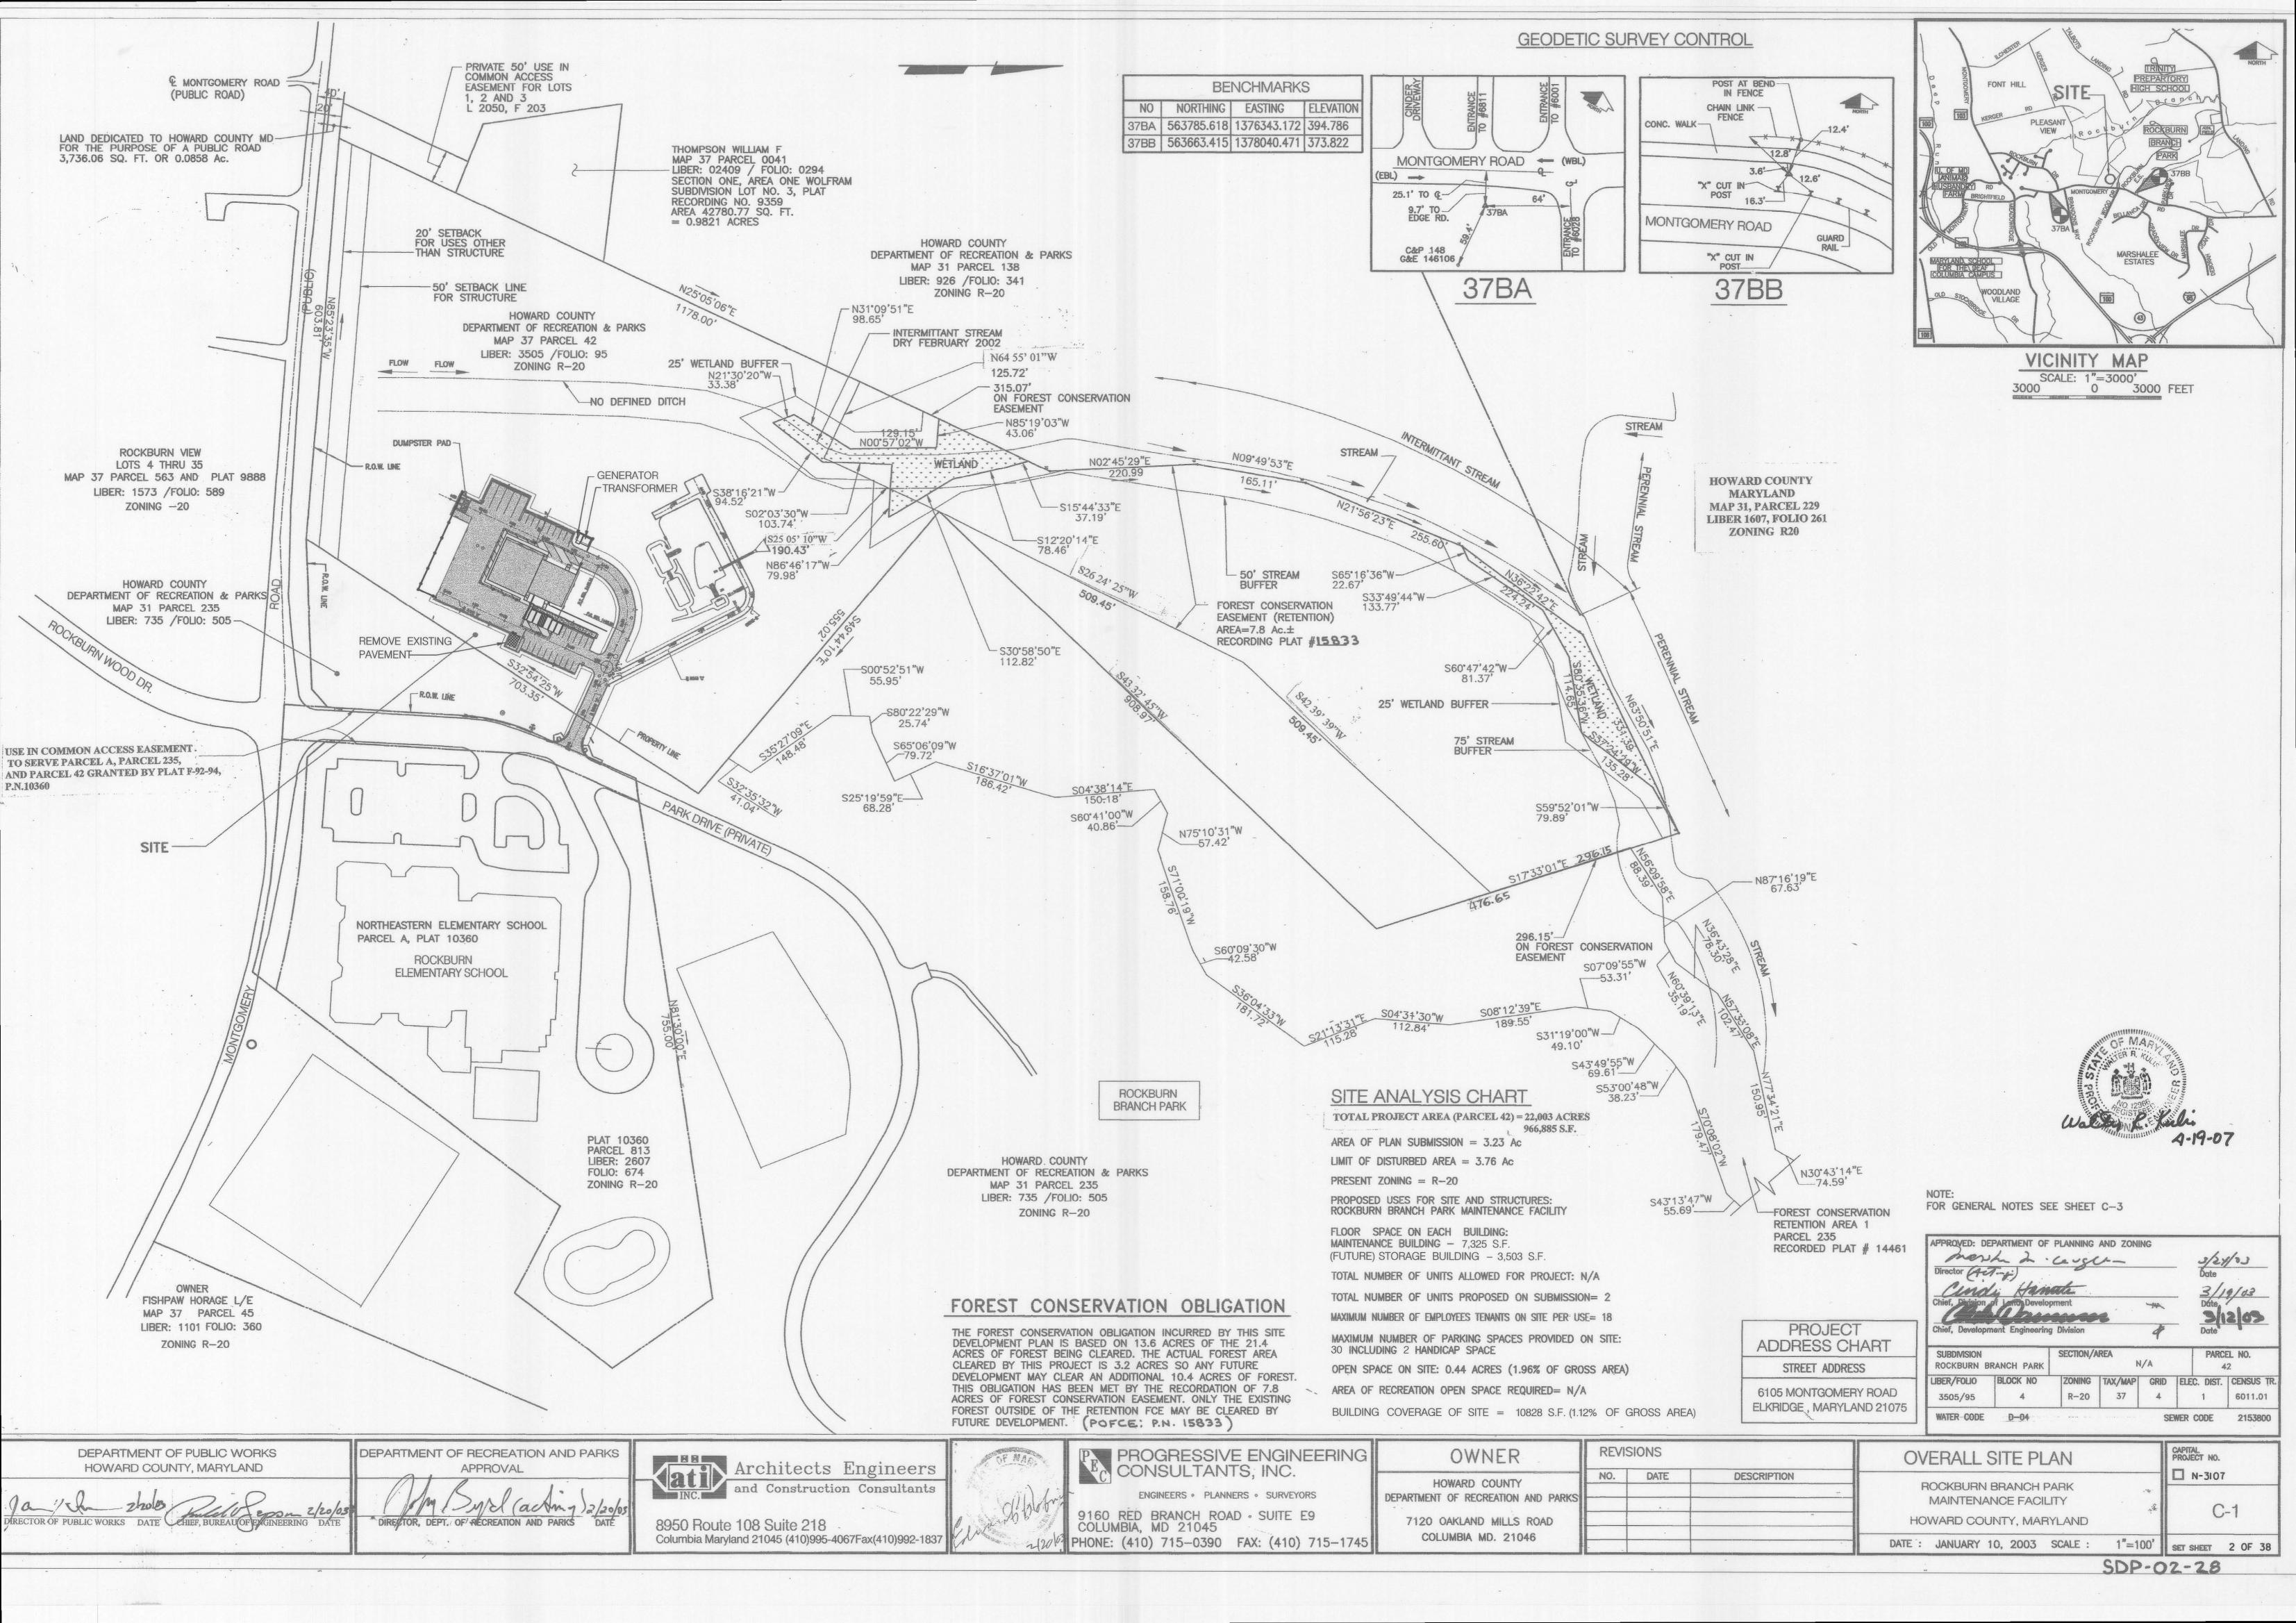

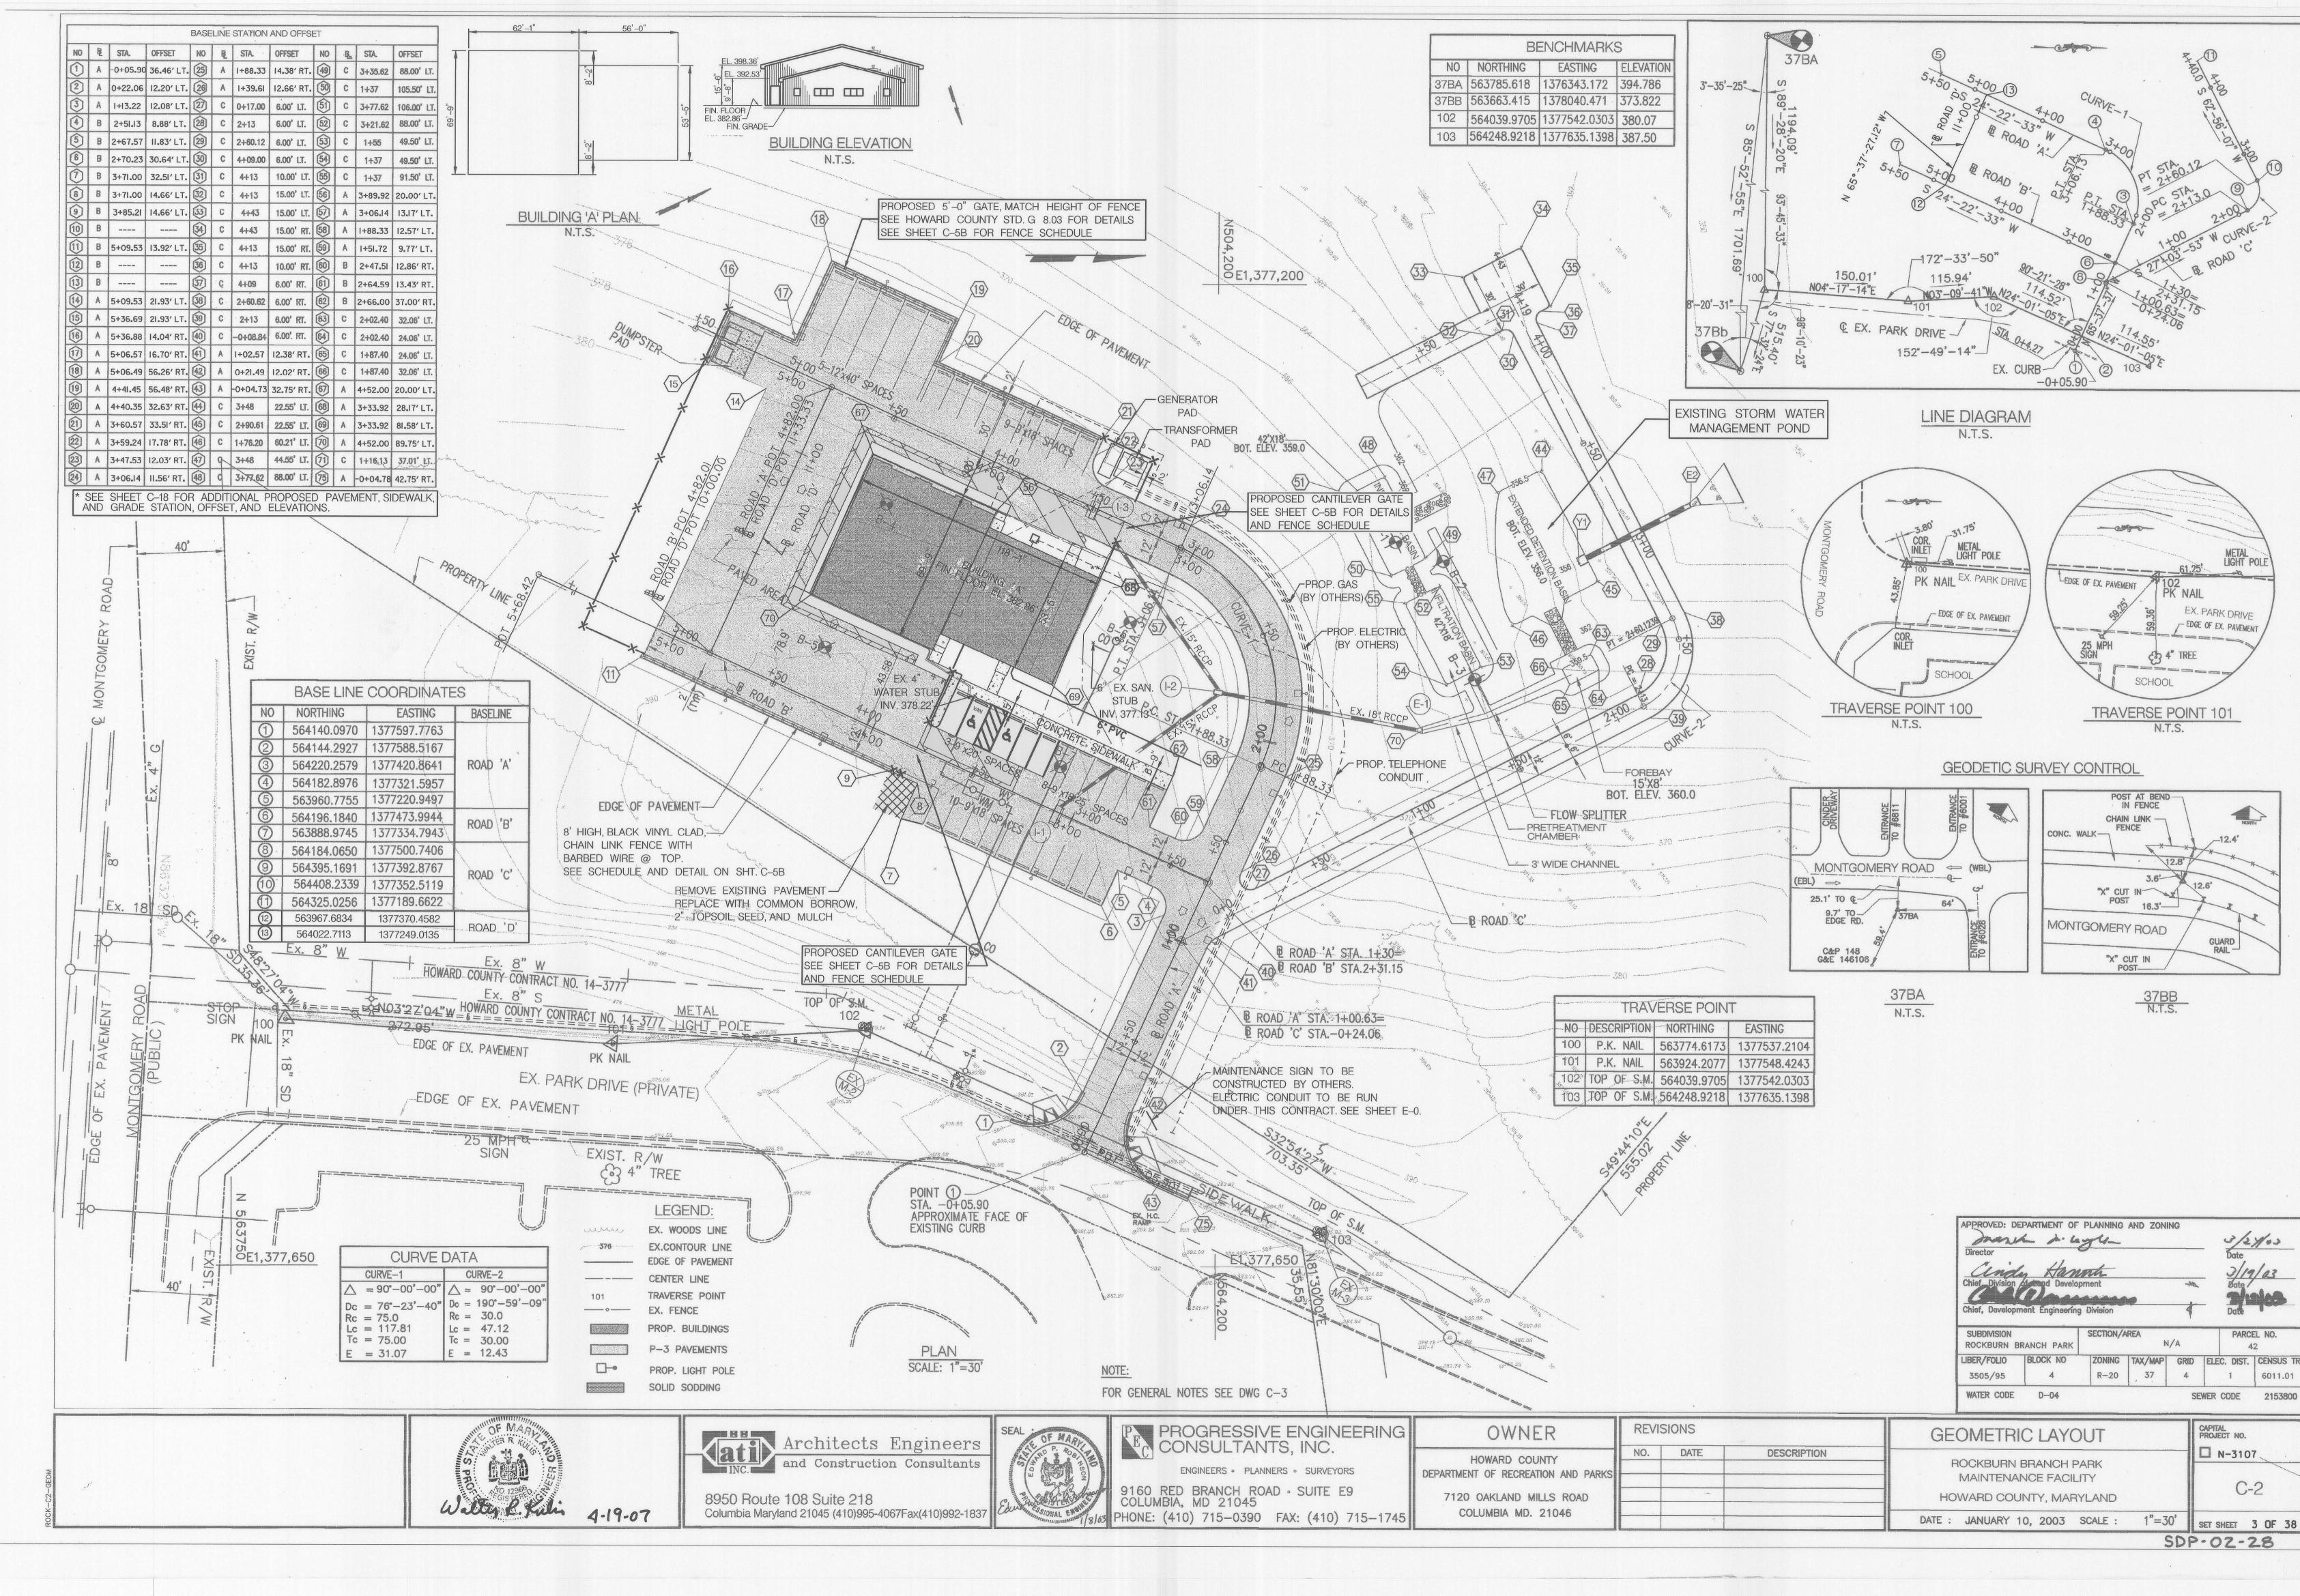

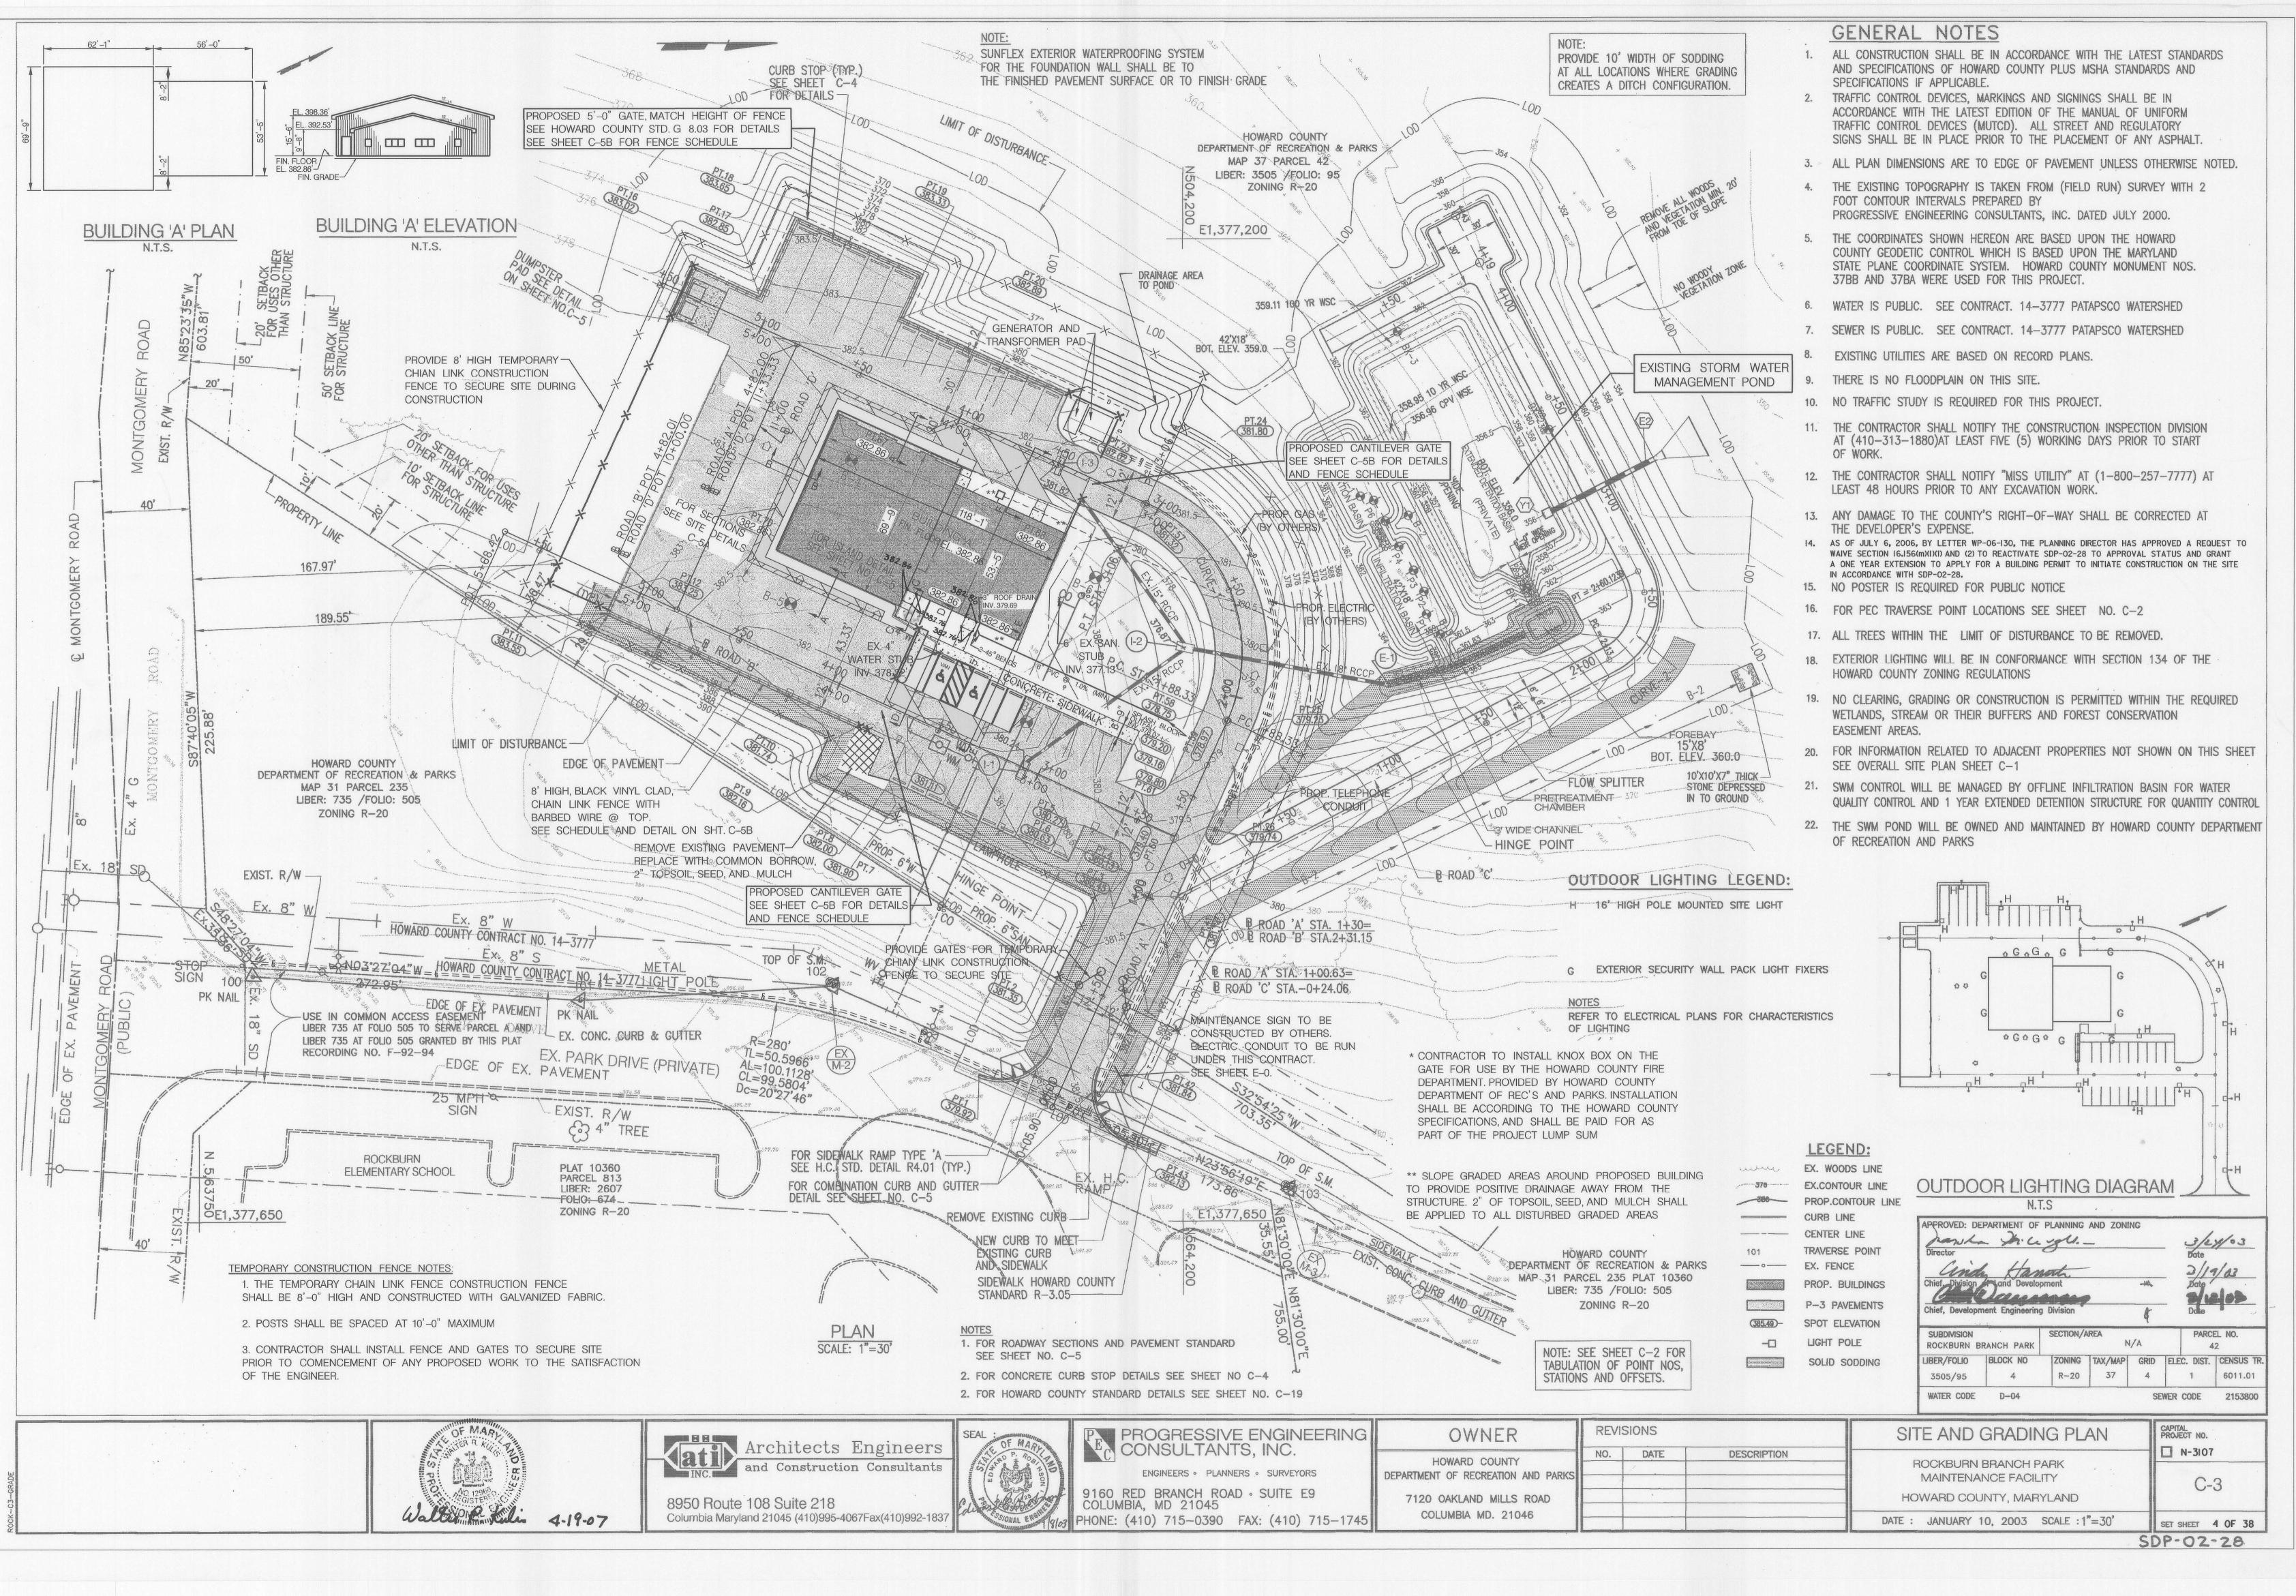

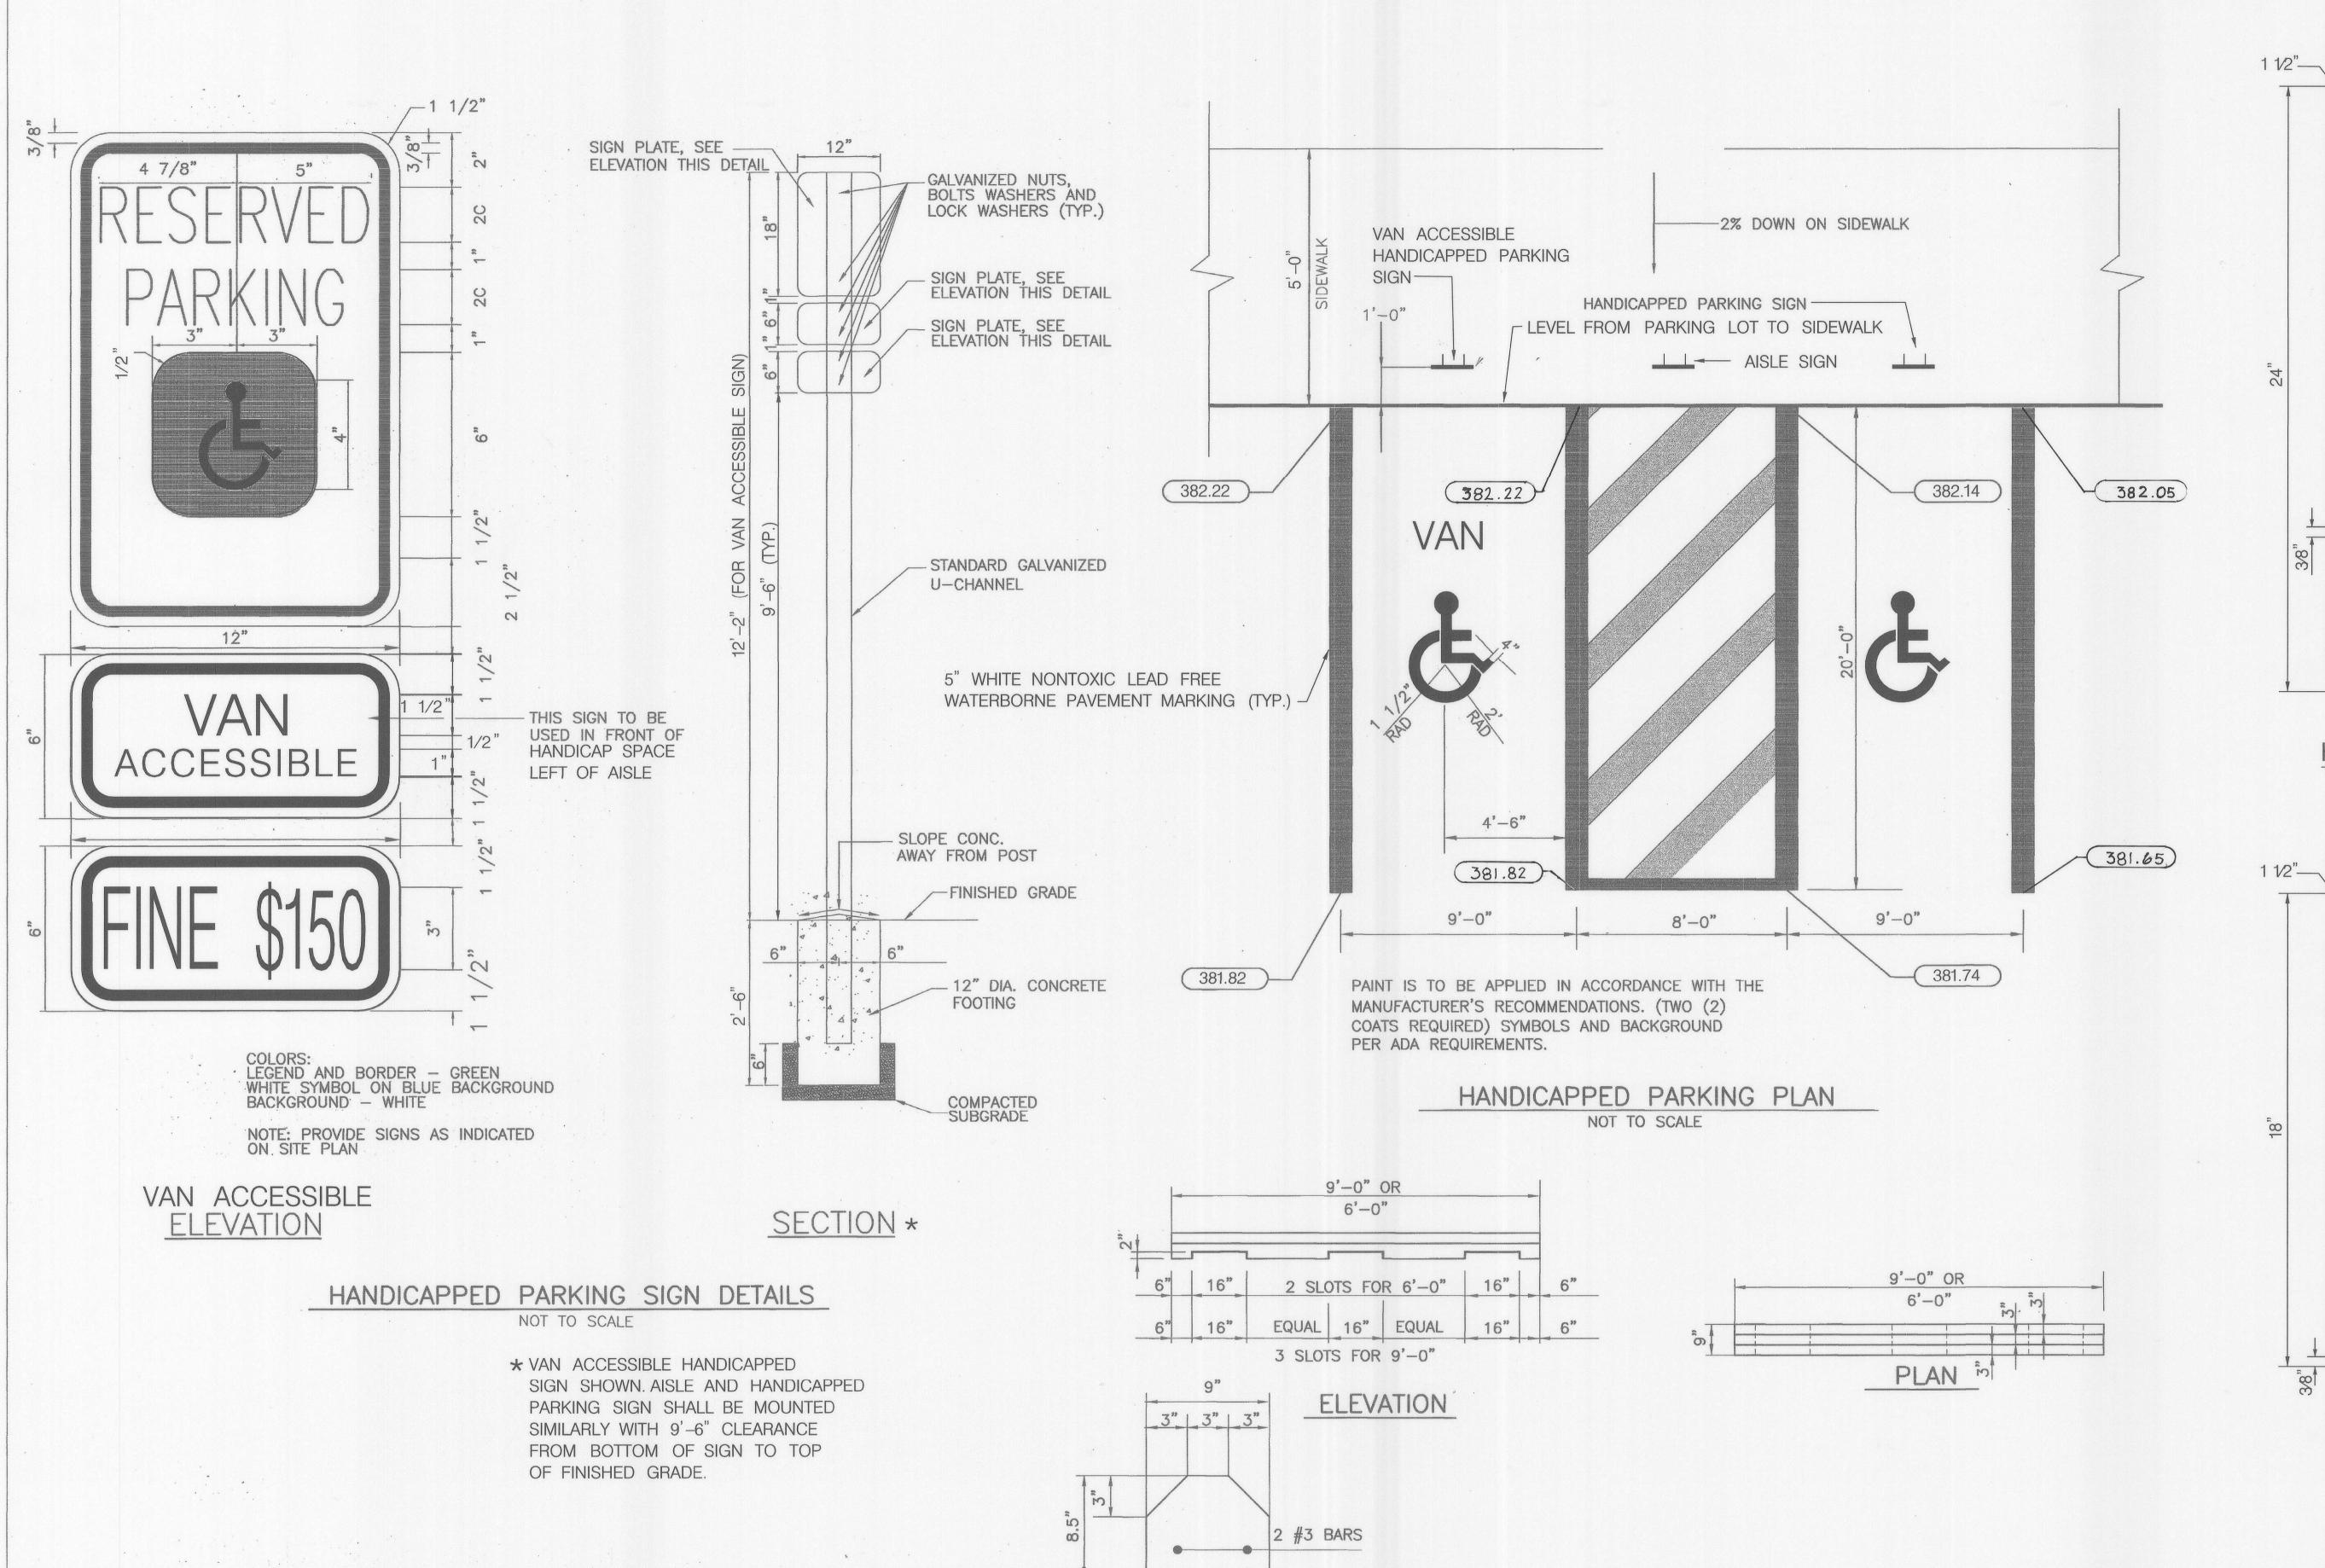

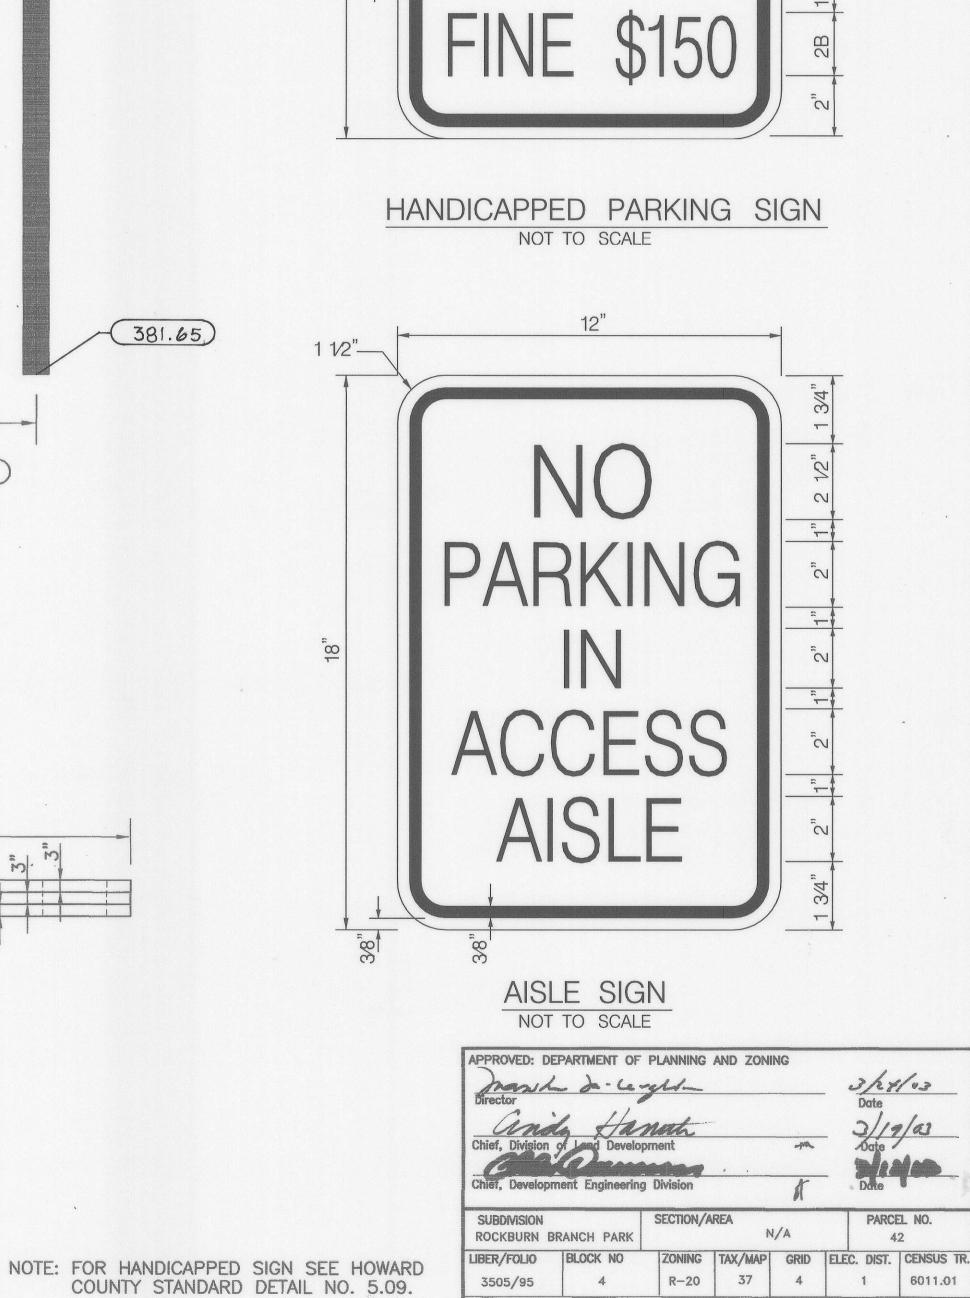





Architects Engineers and Construction Consultants

8950 Route 108 Suite 218 Columbia Maryland 21045 (410)995-4067Fax(410)992-183



SECTION

PEC PROGRESSIVE ENGINEERING CONSULTANTS, INC.

CONCRETE CURB STOP DETAILS

NOT TO SCALE

ENGINEERS · PLANNERS · SURVEYORS 9160 RED BRANCH ROAD - SUITE E9 COLUMBIA, MD 21045 PHONE: (410) 715-0390 FAX: (410) 715-1745

OWNER	REVIS	SIONS		
HOWARD COUNTY DEPARTMENT OF RECREATION AND PARKS	NO.	DATE	DESCRIPTION	
7120 OAKLAND MILLS ROAD				


The second secon	HANDICAPPED PARKING PLAN	CAPITAL PROJECT NO.
	ROCKBURN BRANCH PARK MAINTENANCE FACILITY	N-3107
SECTION AND PROPERTY.	HOWARD COUNTY, MARYLAND	C-4
- American	DATE : JANUARY 10, 2003 SCALE : AS SHOWN	SET SHEET 5 OF 38


3505/95


WATER CODE D-04

SDP-02-28

SEWER CODE

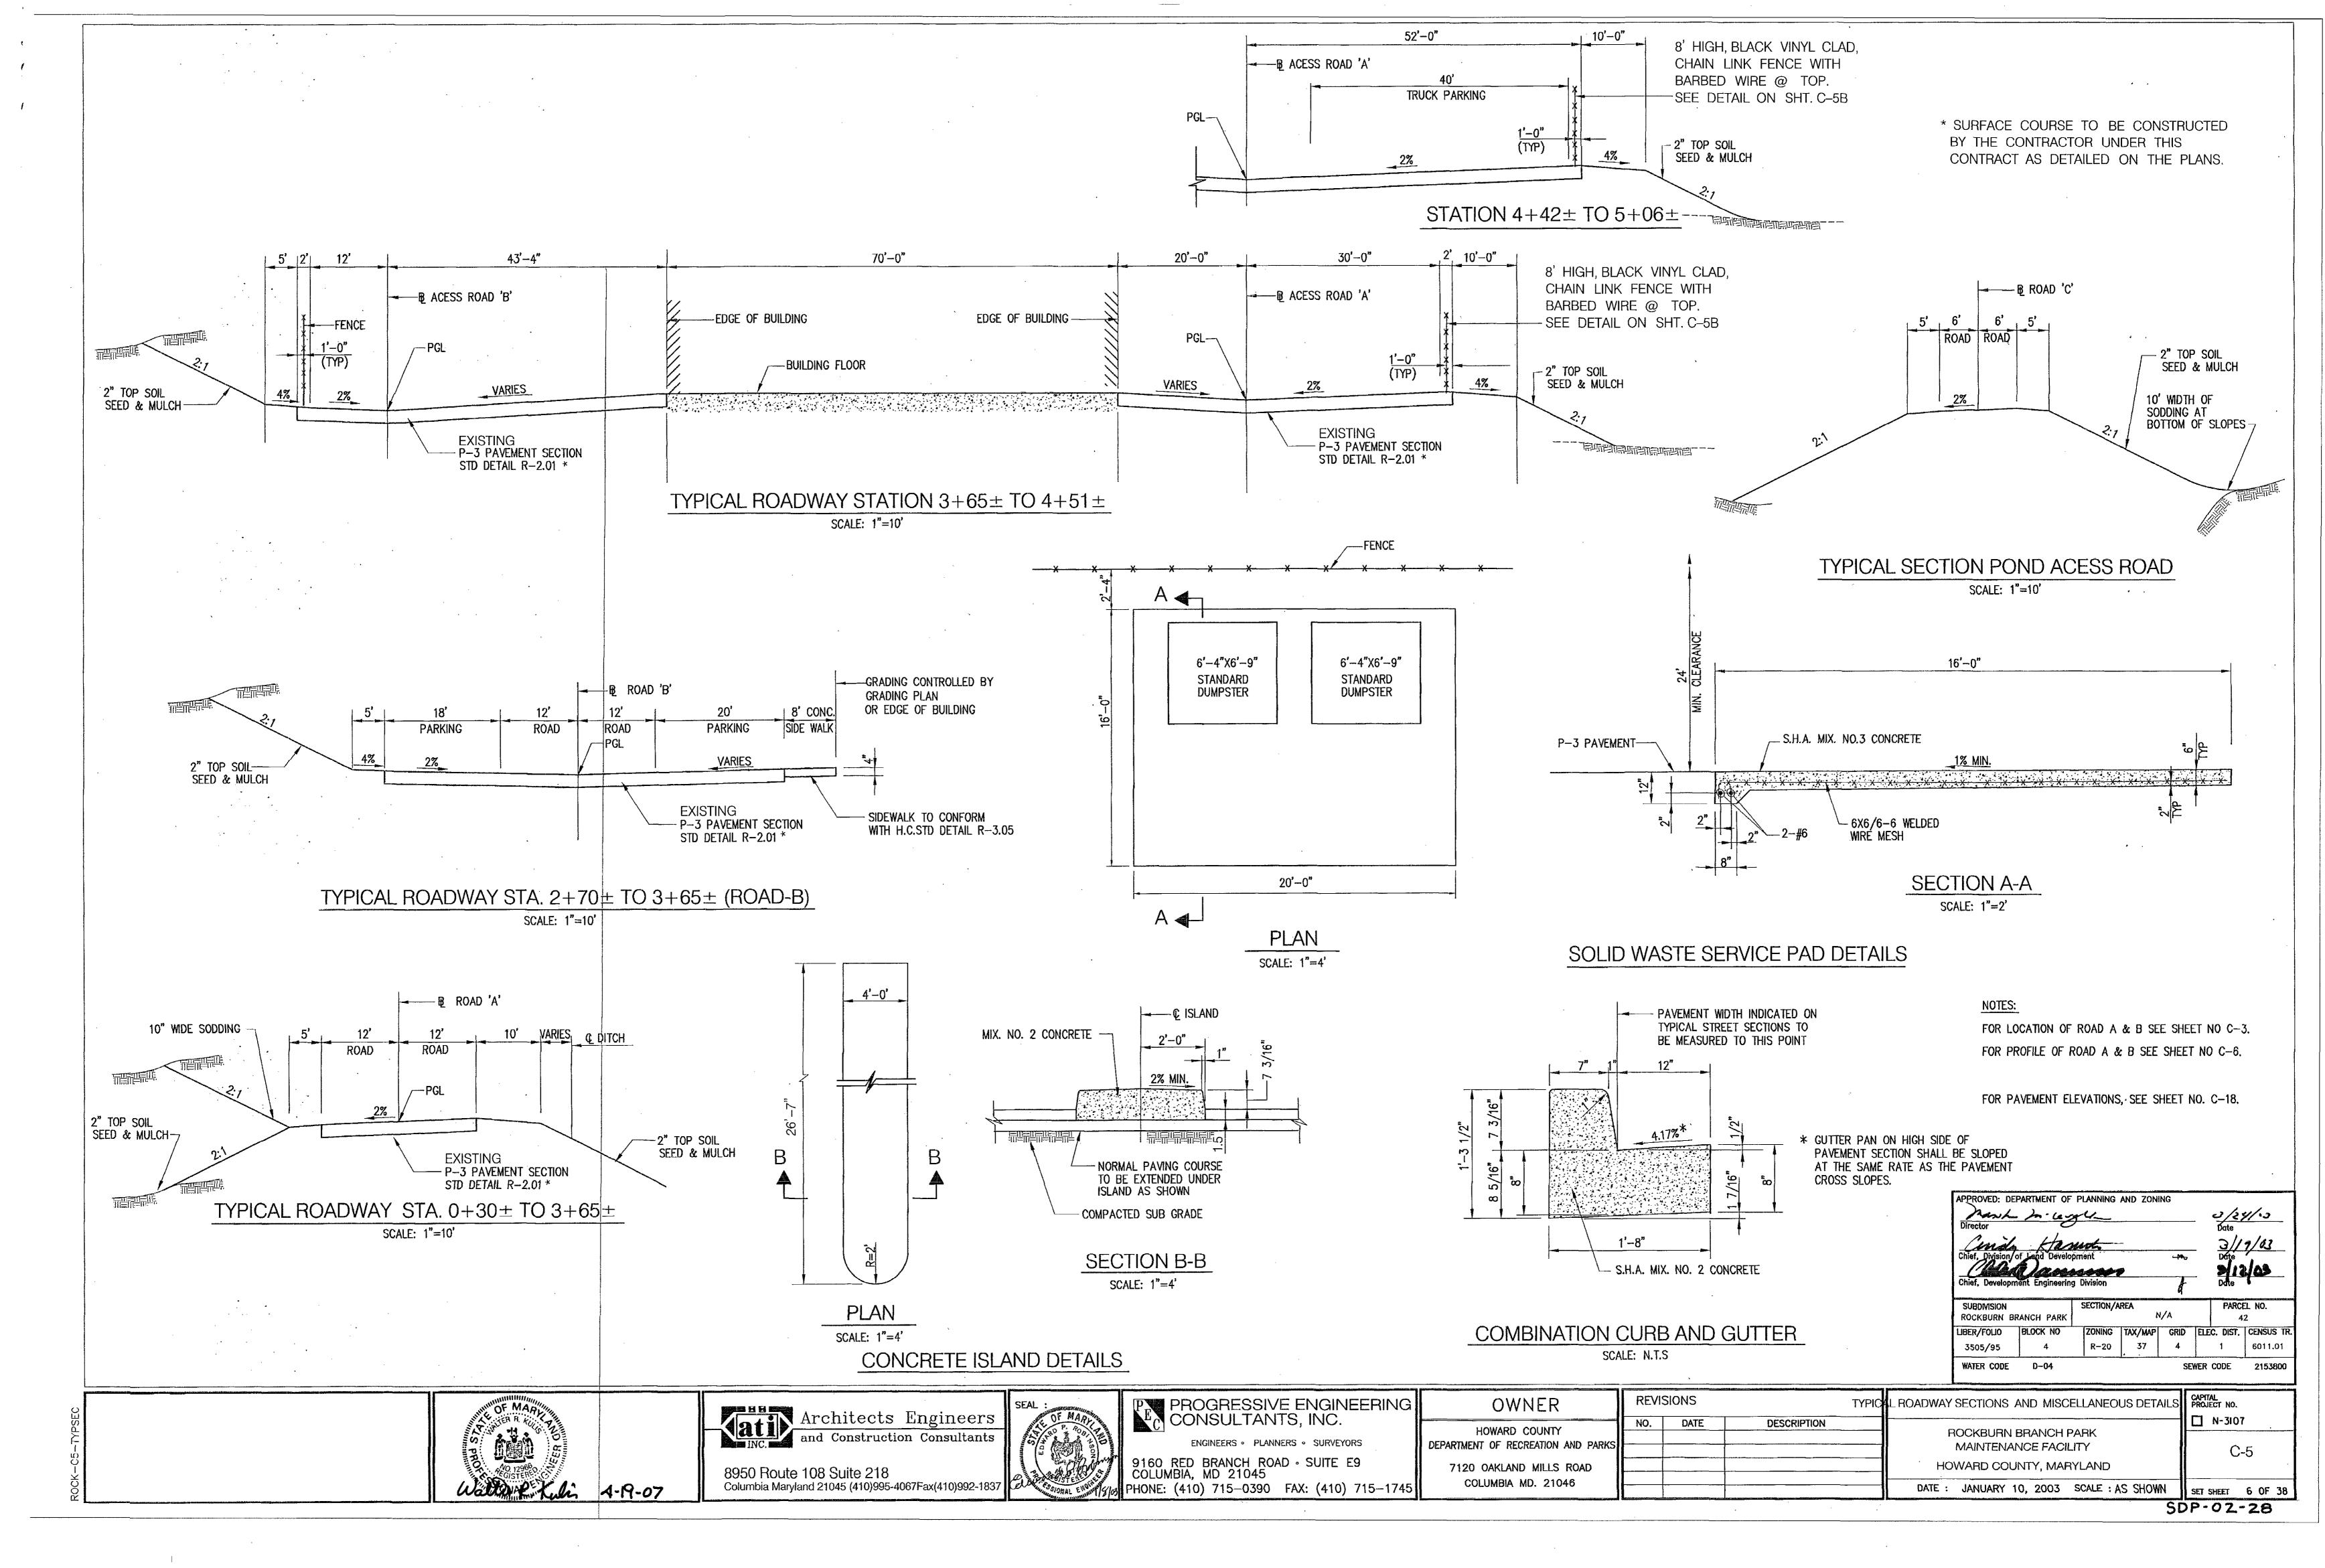

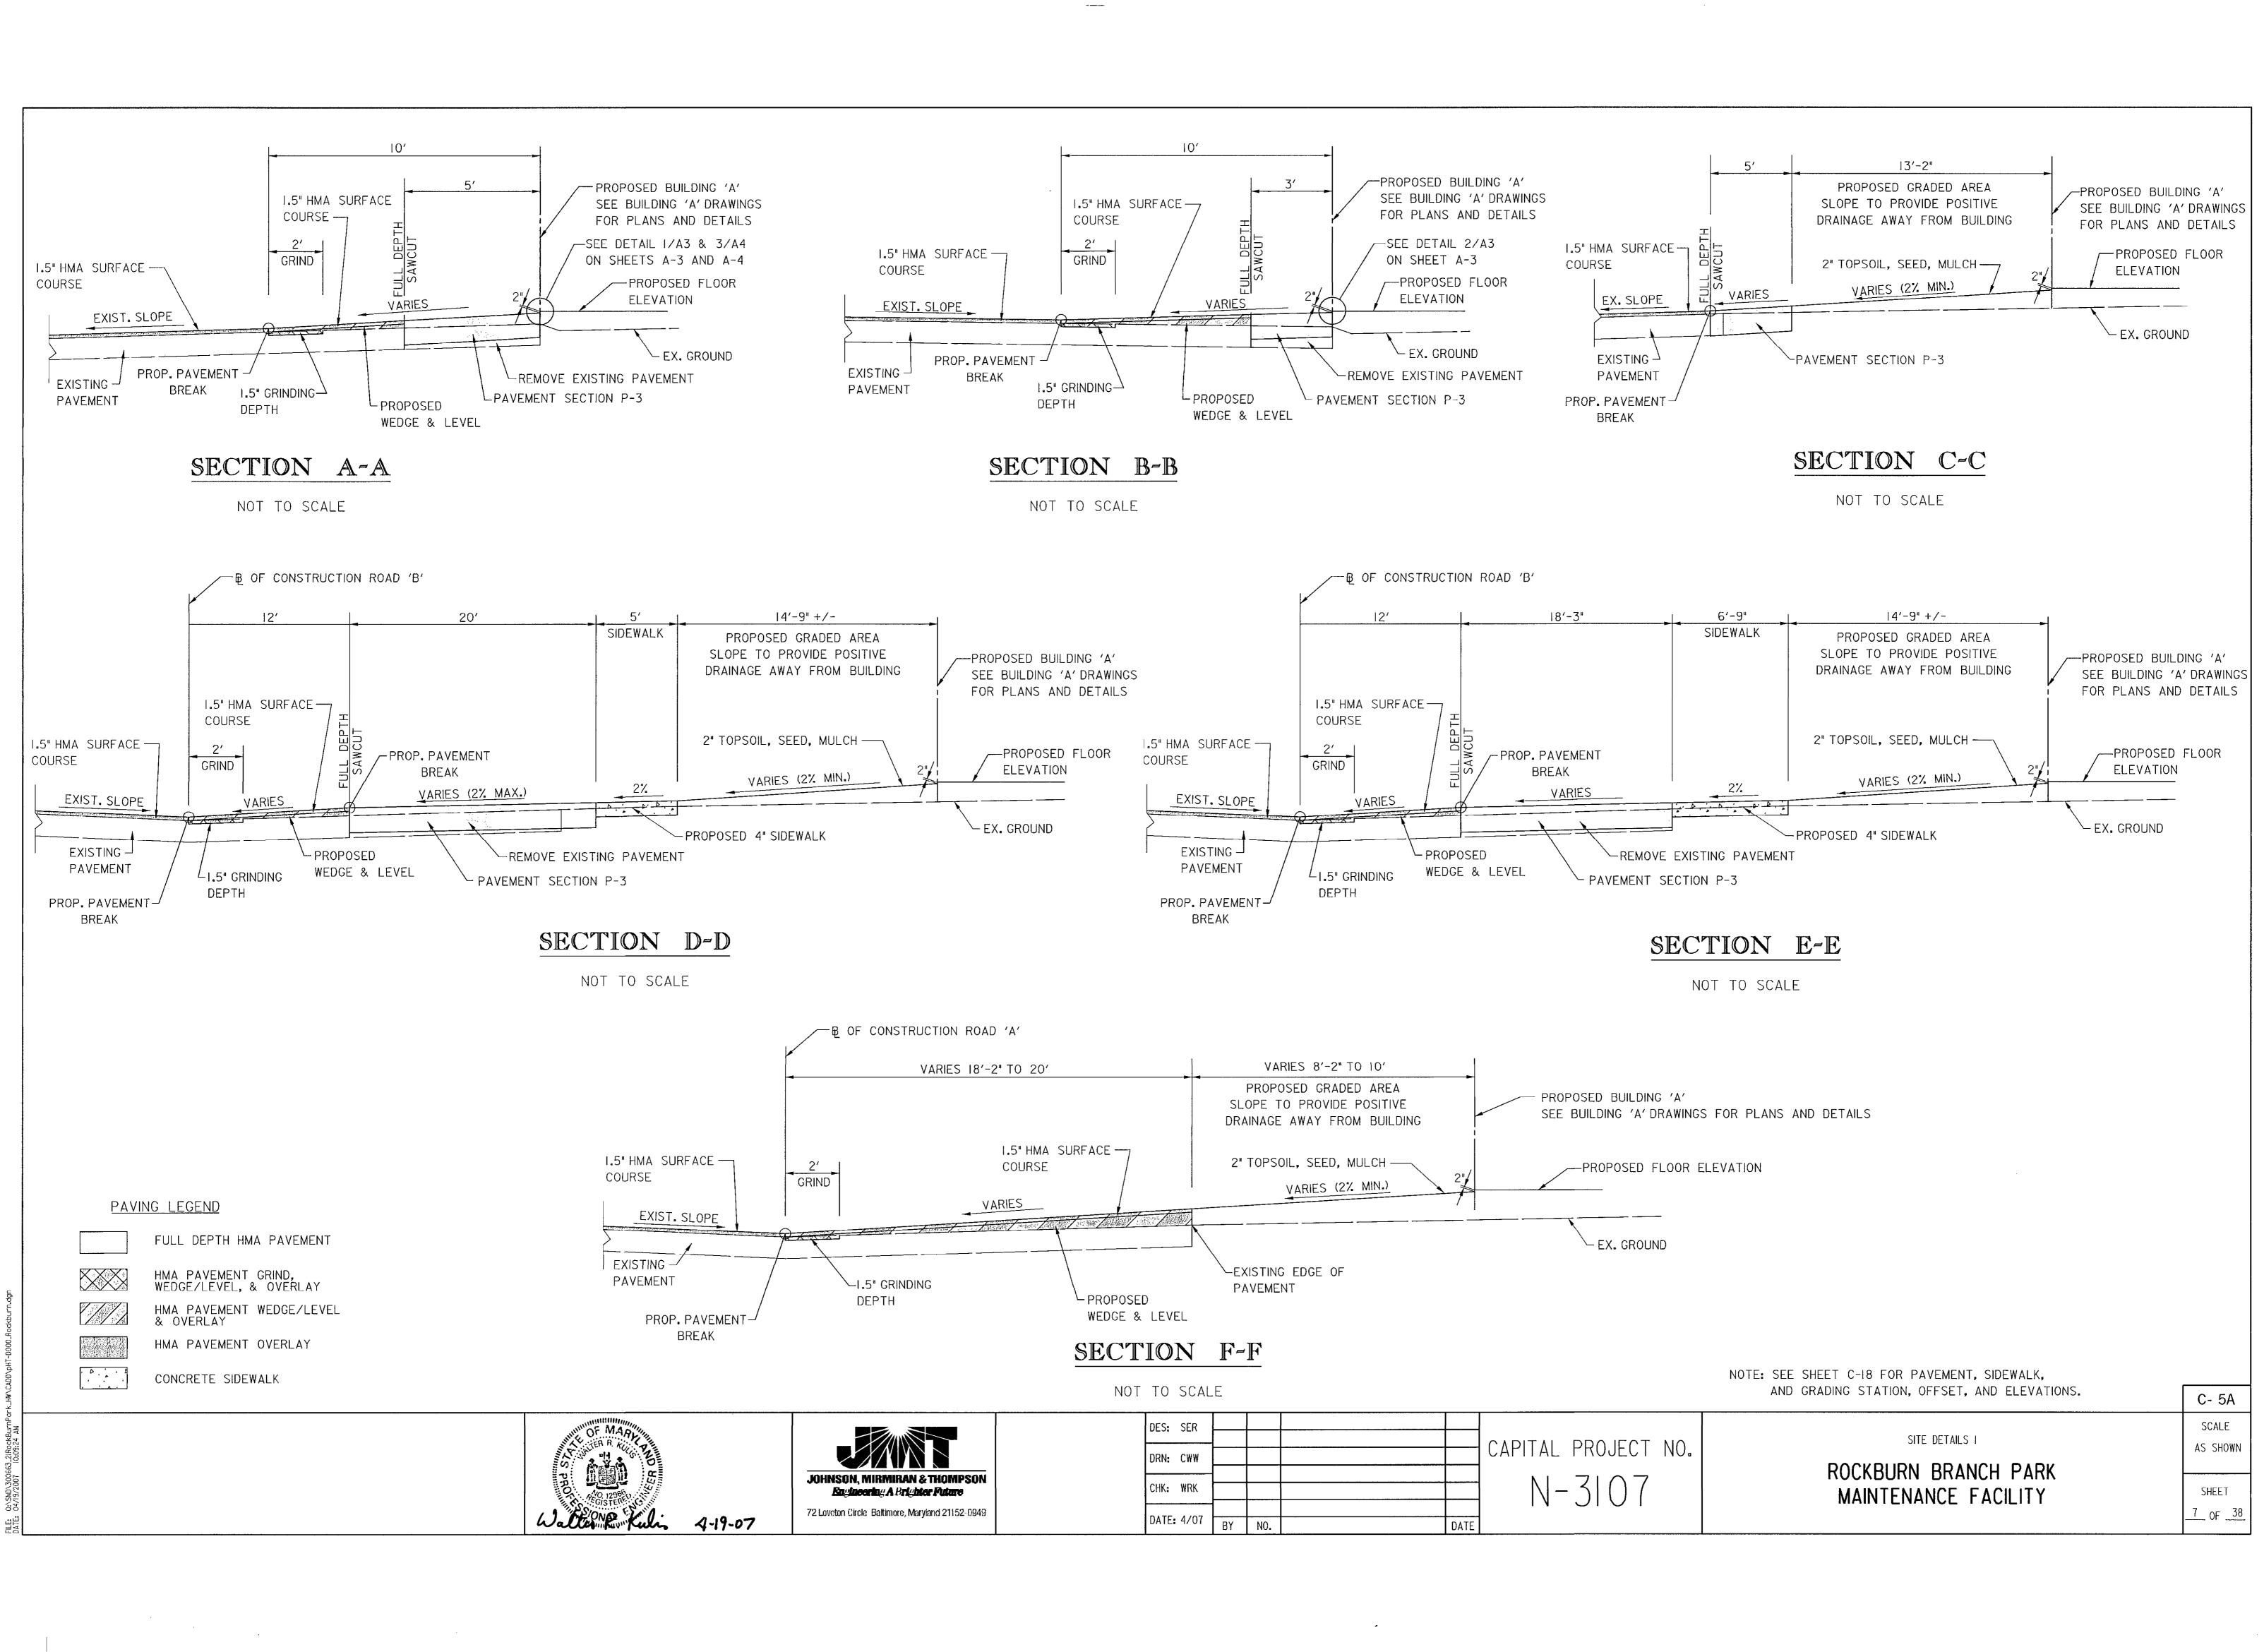


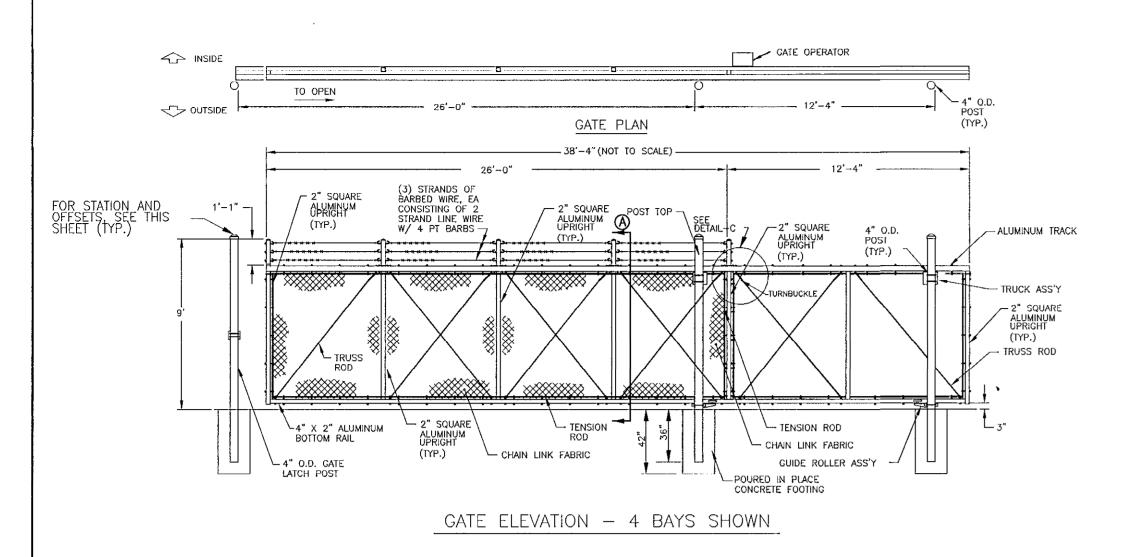

1. FOOTING WIDTH TO BE 4 X POST WIDTH.

SINGLE CANTILEVER SLIDING GATE DETAIL


NOT TO SCALE

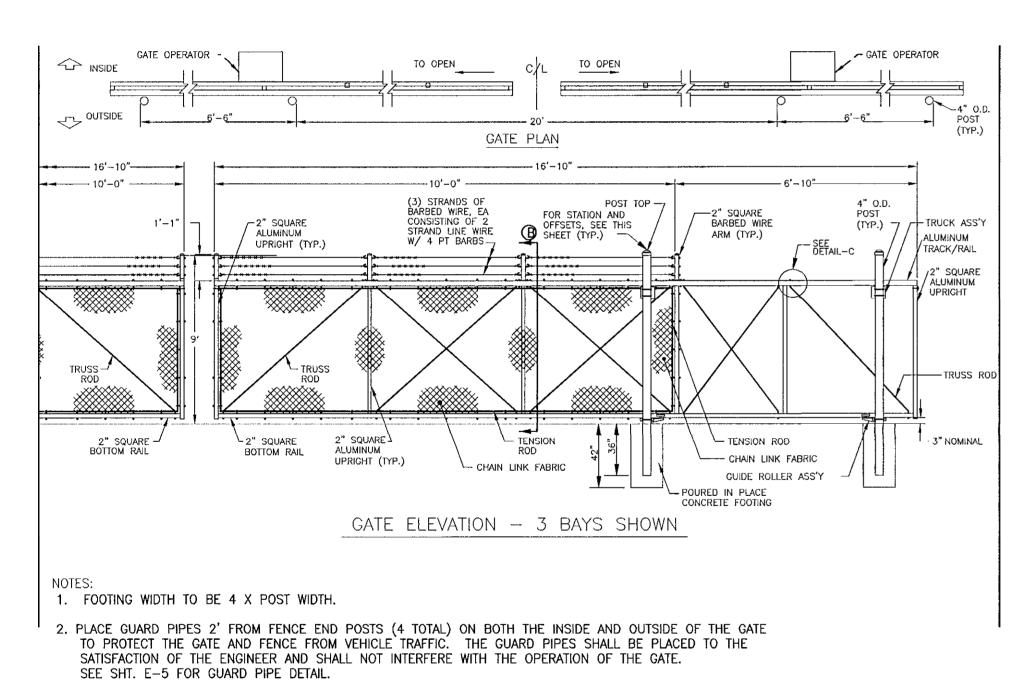



DOUBLE CANTILEVER SLIDING GATE DETAIL


ROAD 'A'

NOT TO SCALE

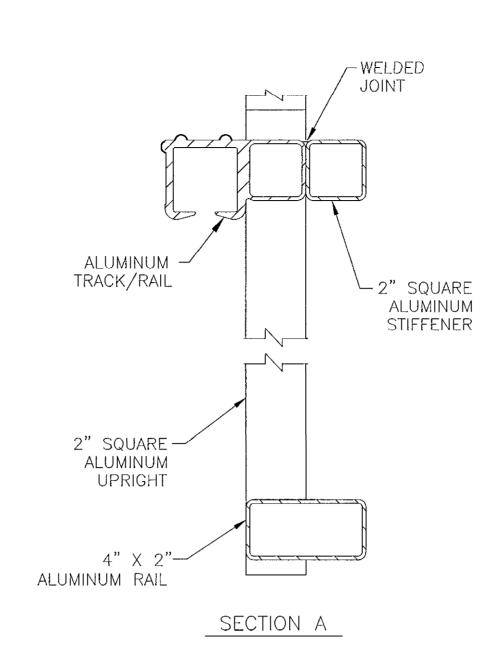

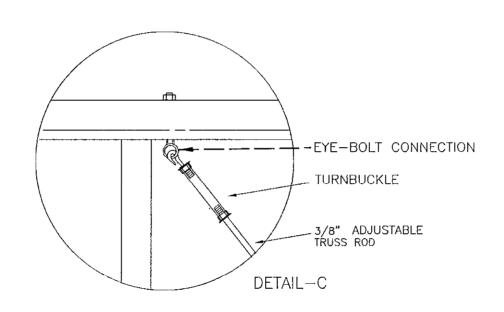

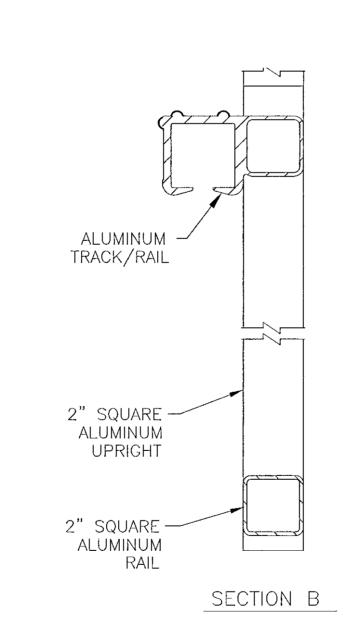

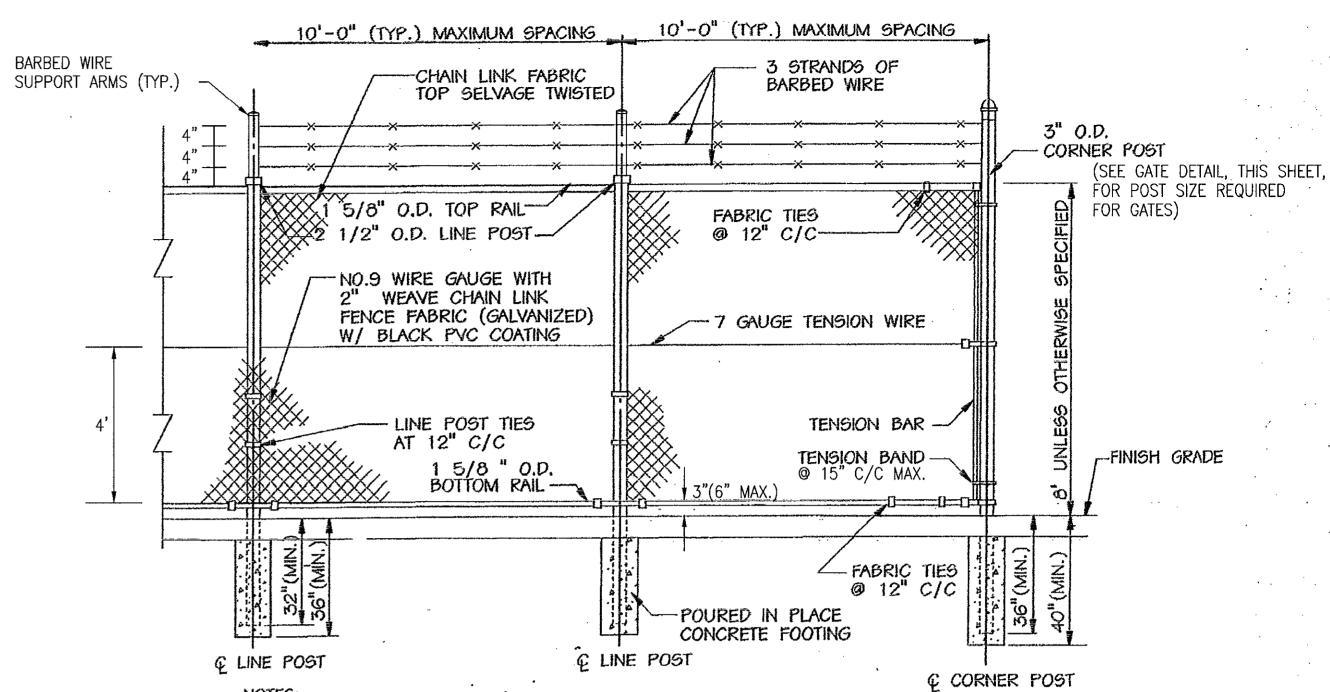

NOTES:

1. CONTRACTOR SHALL EXERCISE EXTREME CARE WHEN INSTALLING FENCE SO AS NOT TO DAMAGE UNDERGROUND UTILITIES.

2. INSTALL FABRIC ON OUTSIDE OF FENCE.


3. KNUCKLE SELVAGE TOP AND BOTTOM OF FABRIC.

4. ALL CHAIN LINK, FABRIC, POSTS AND FITTINGS SHALL BE GALVANIZED WITH BLACK PVC COATING.

5. EXCAVATE HOLES FOR EACH POST TO A MINIMUM OF FOUR TIMES THE DIAMETER OF THE POST.

CHAIN LINK FENCE DETAIL

		CHIN	LINK FEN	CE SCHEDULE
FENCE RUN	BASELINE	STATION	OFFSET	REMARKS
1	ROAD 'A'	3+33.92	28.17', LT.	MEET CORNER OF BUILDING
No.	ROAD 'A'	3+33.92	10.00′, LT.	END OF FENCE, GATE END POST
2	ROAD 'A'	3+33.92	10.00′, RT.	END OF FENCE, GATE END POST
	ROAD 'A'	3+33.92	32.50′, RT.	FENCE CORNER
	ROAD 'A'	4+41.35	31.50′, RT.	FENCE CORNER
	ROAD 'A'	4+42.45	55.50′, RT.	FENCE CORNER
	ROAD 'A'	5+00.50	55.25′, RT.	END OF FENCE, GATE END POST
3	ROAD 'A'	5+05.50	55.25′, RT.	END OF FENCE, GATE END POST
	ROAD 'A'	5+05.50	13.60′, RT.	FENCE CORNER
	ROAD 'A'	5+40.15	13.00′, RT.	FENCE CORNER
	ROAD 'B'	5+40.15	13.00′, LT.	FENCE CORNER
	ROAD 'B'	3+78.00	13.00′, LT.	END OF FENCE, GATE END POST
4	ROAD 'B'	3+78.00	13.00′, RT.	END OF FENCE, GATE END POST
	ROAD 'B'	3+78.00	51.75', RT.	MEET BUILDING

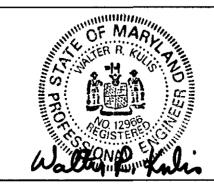




DES: SER				
				؍ ا
DRN: CWW				\
CHK: WRK				
DATE 4/07				
DATE: 4/07	BY	NO.	DATE	
	•			


CAPITAL PROJECT NO. N - 3107


SITE DETAILS 2 ROCKBURN BRANCH PARK MAINTENANCE FACILITY

C- 5B SCALE

8 OF <u>38</u>

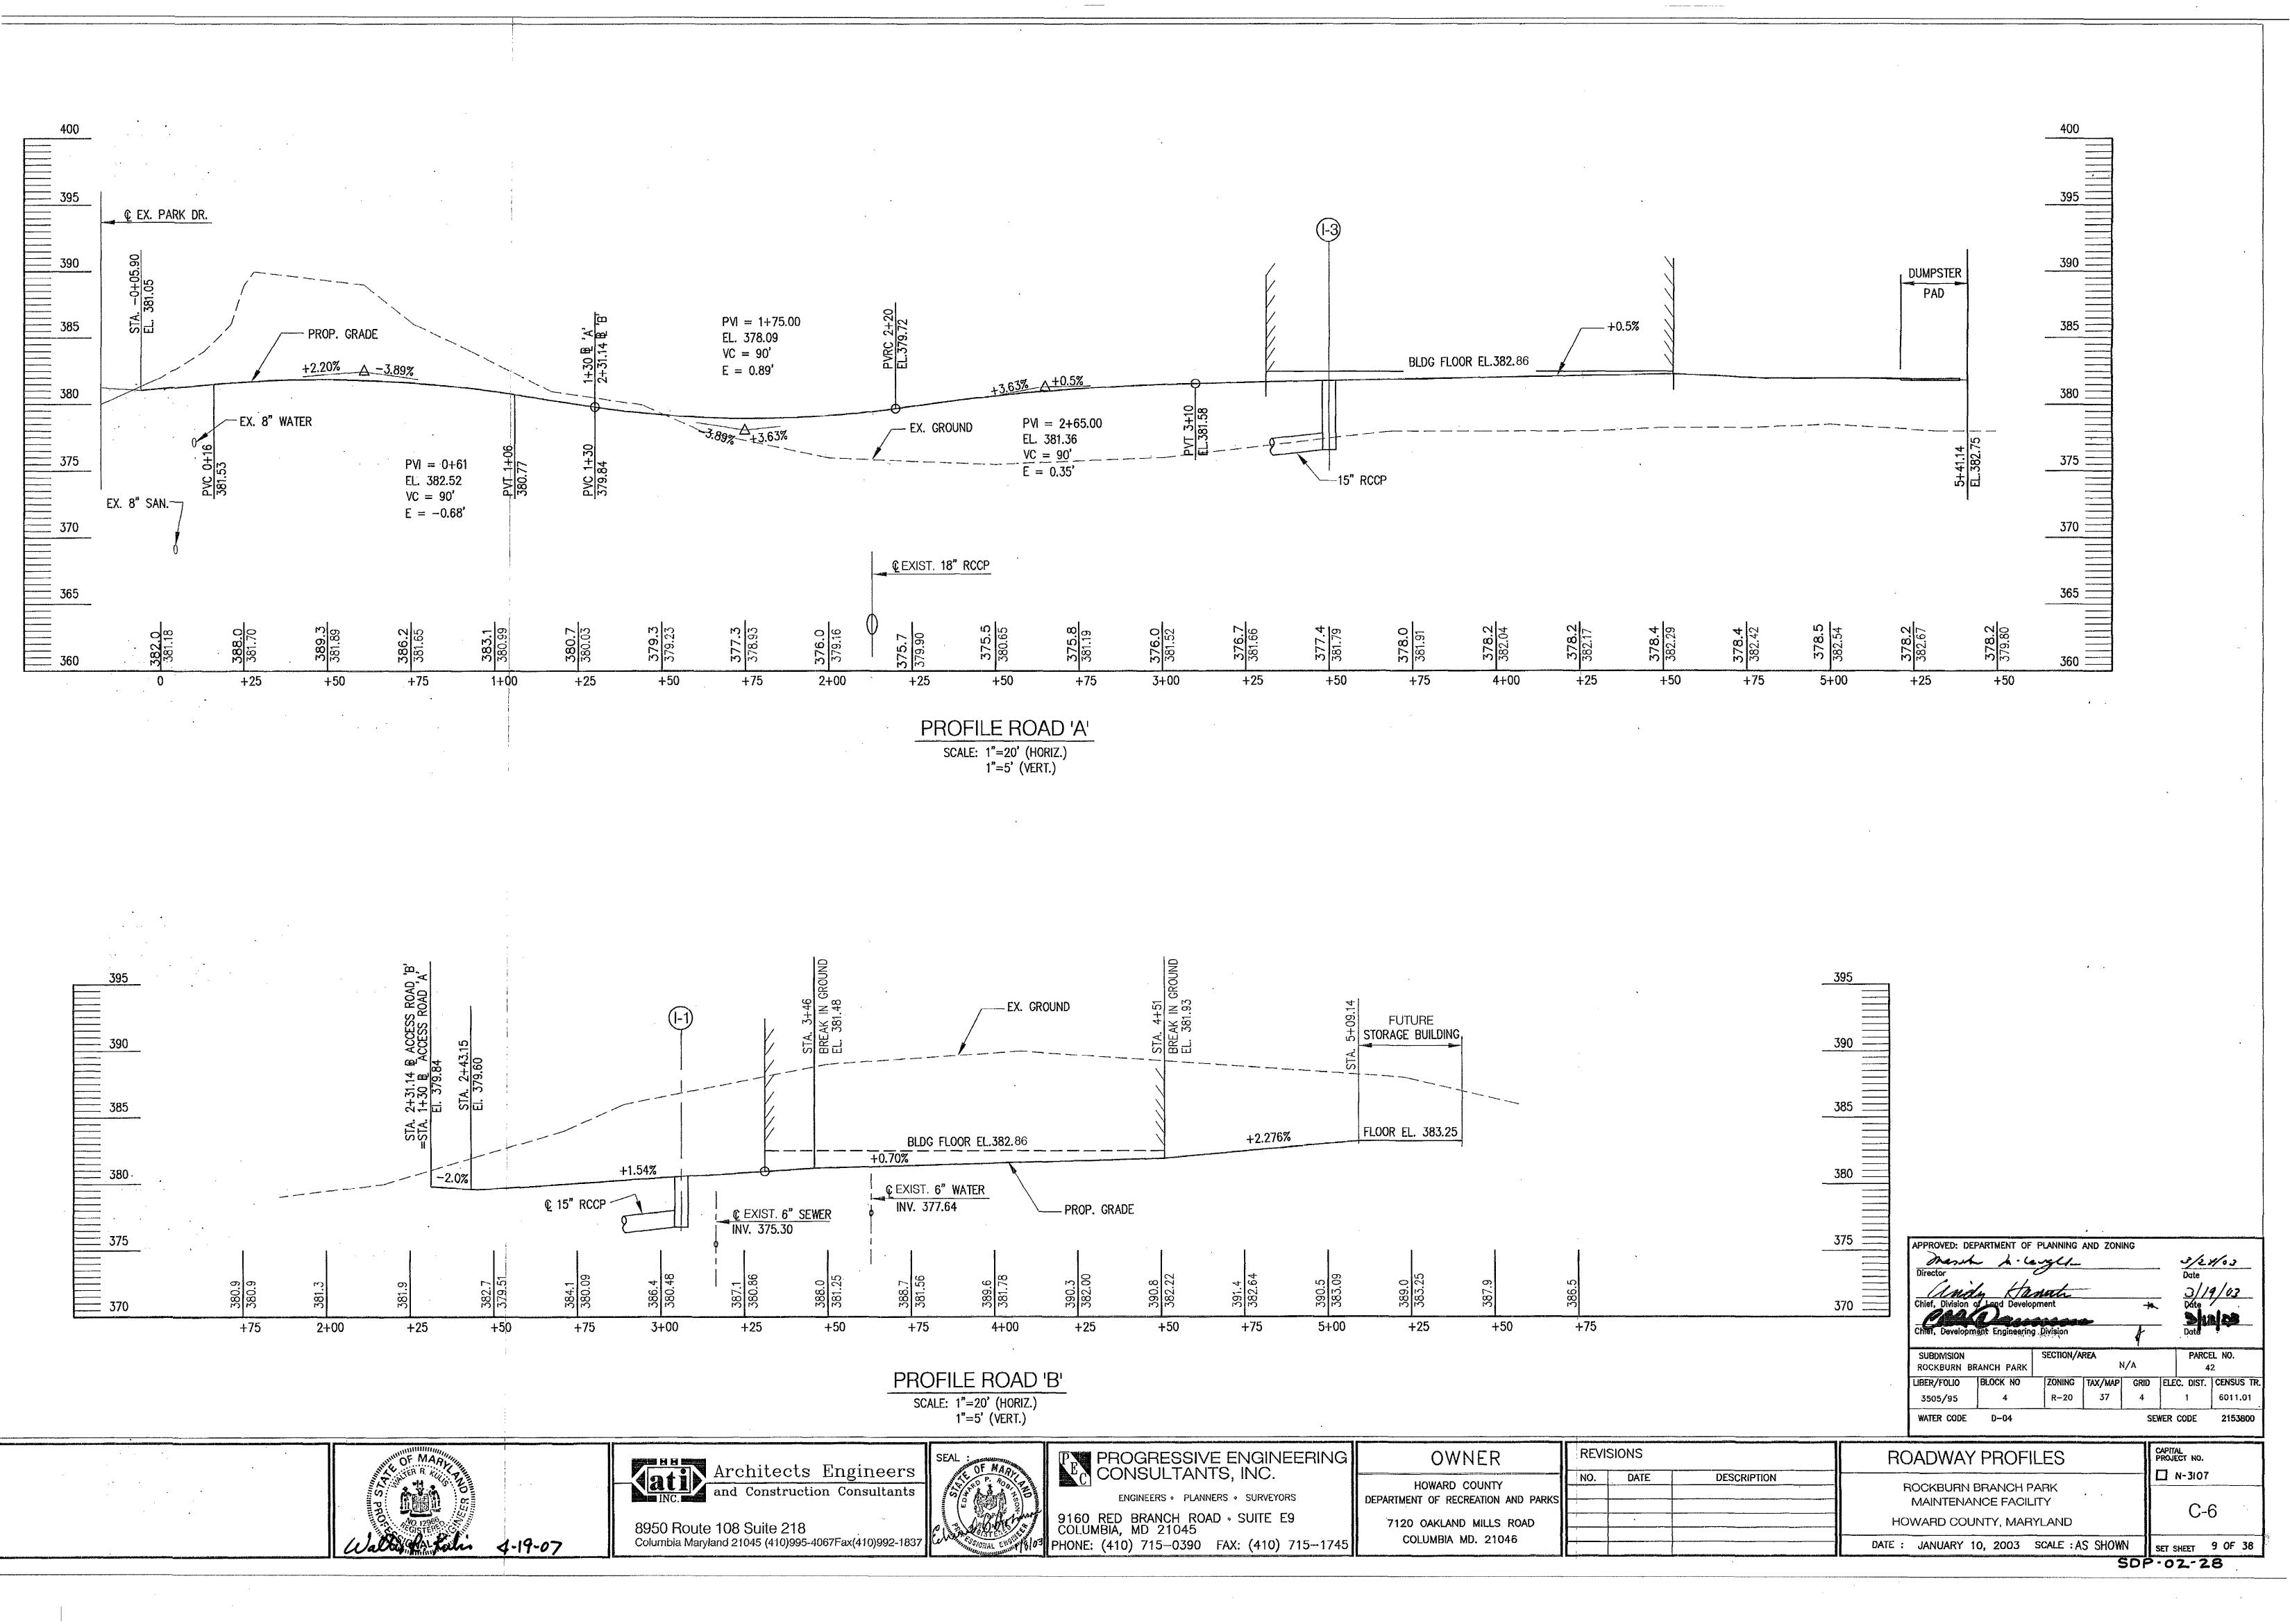


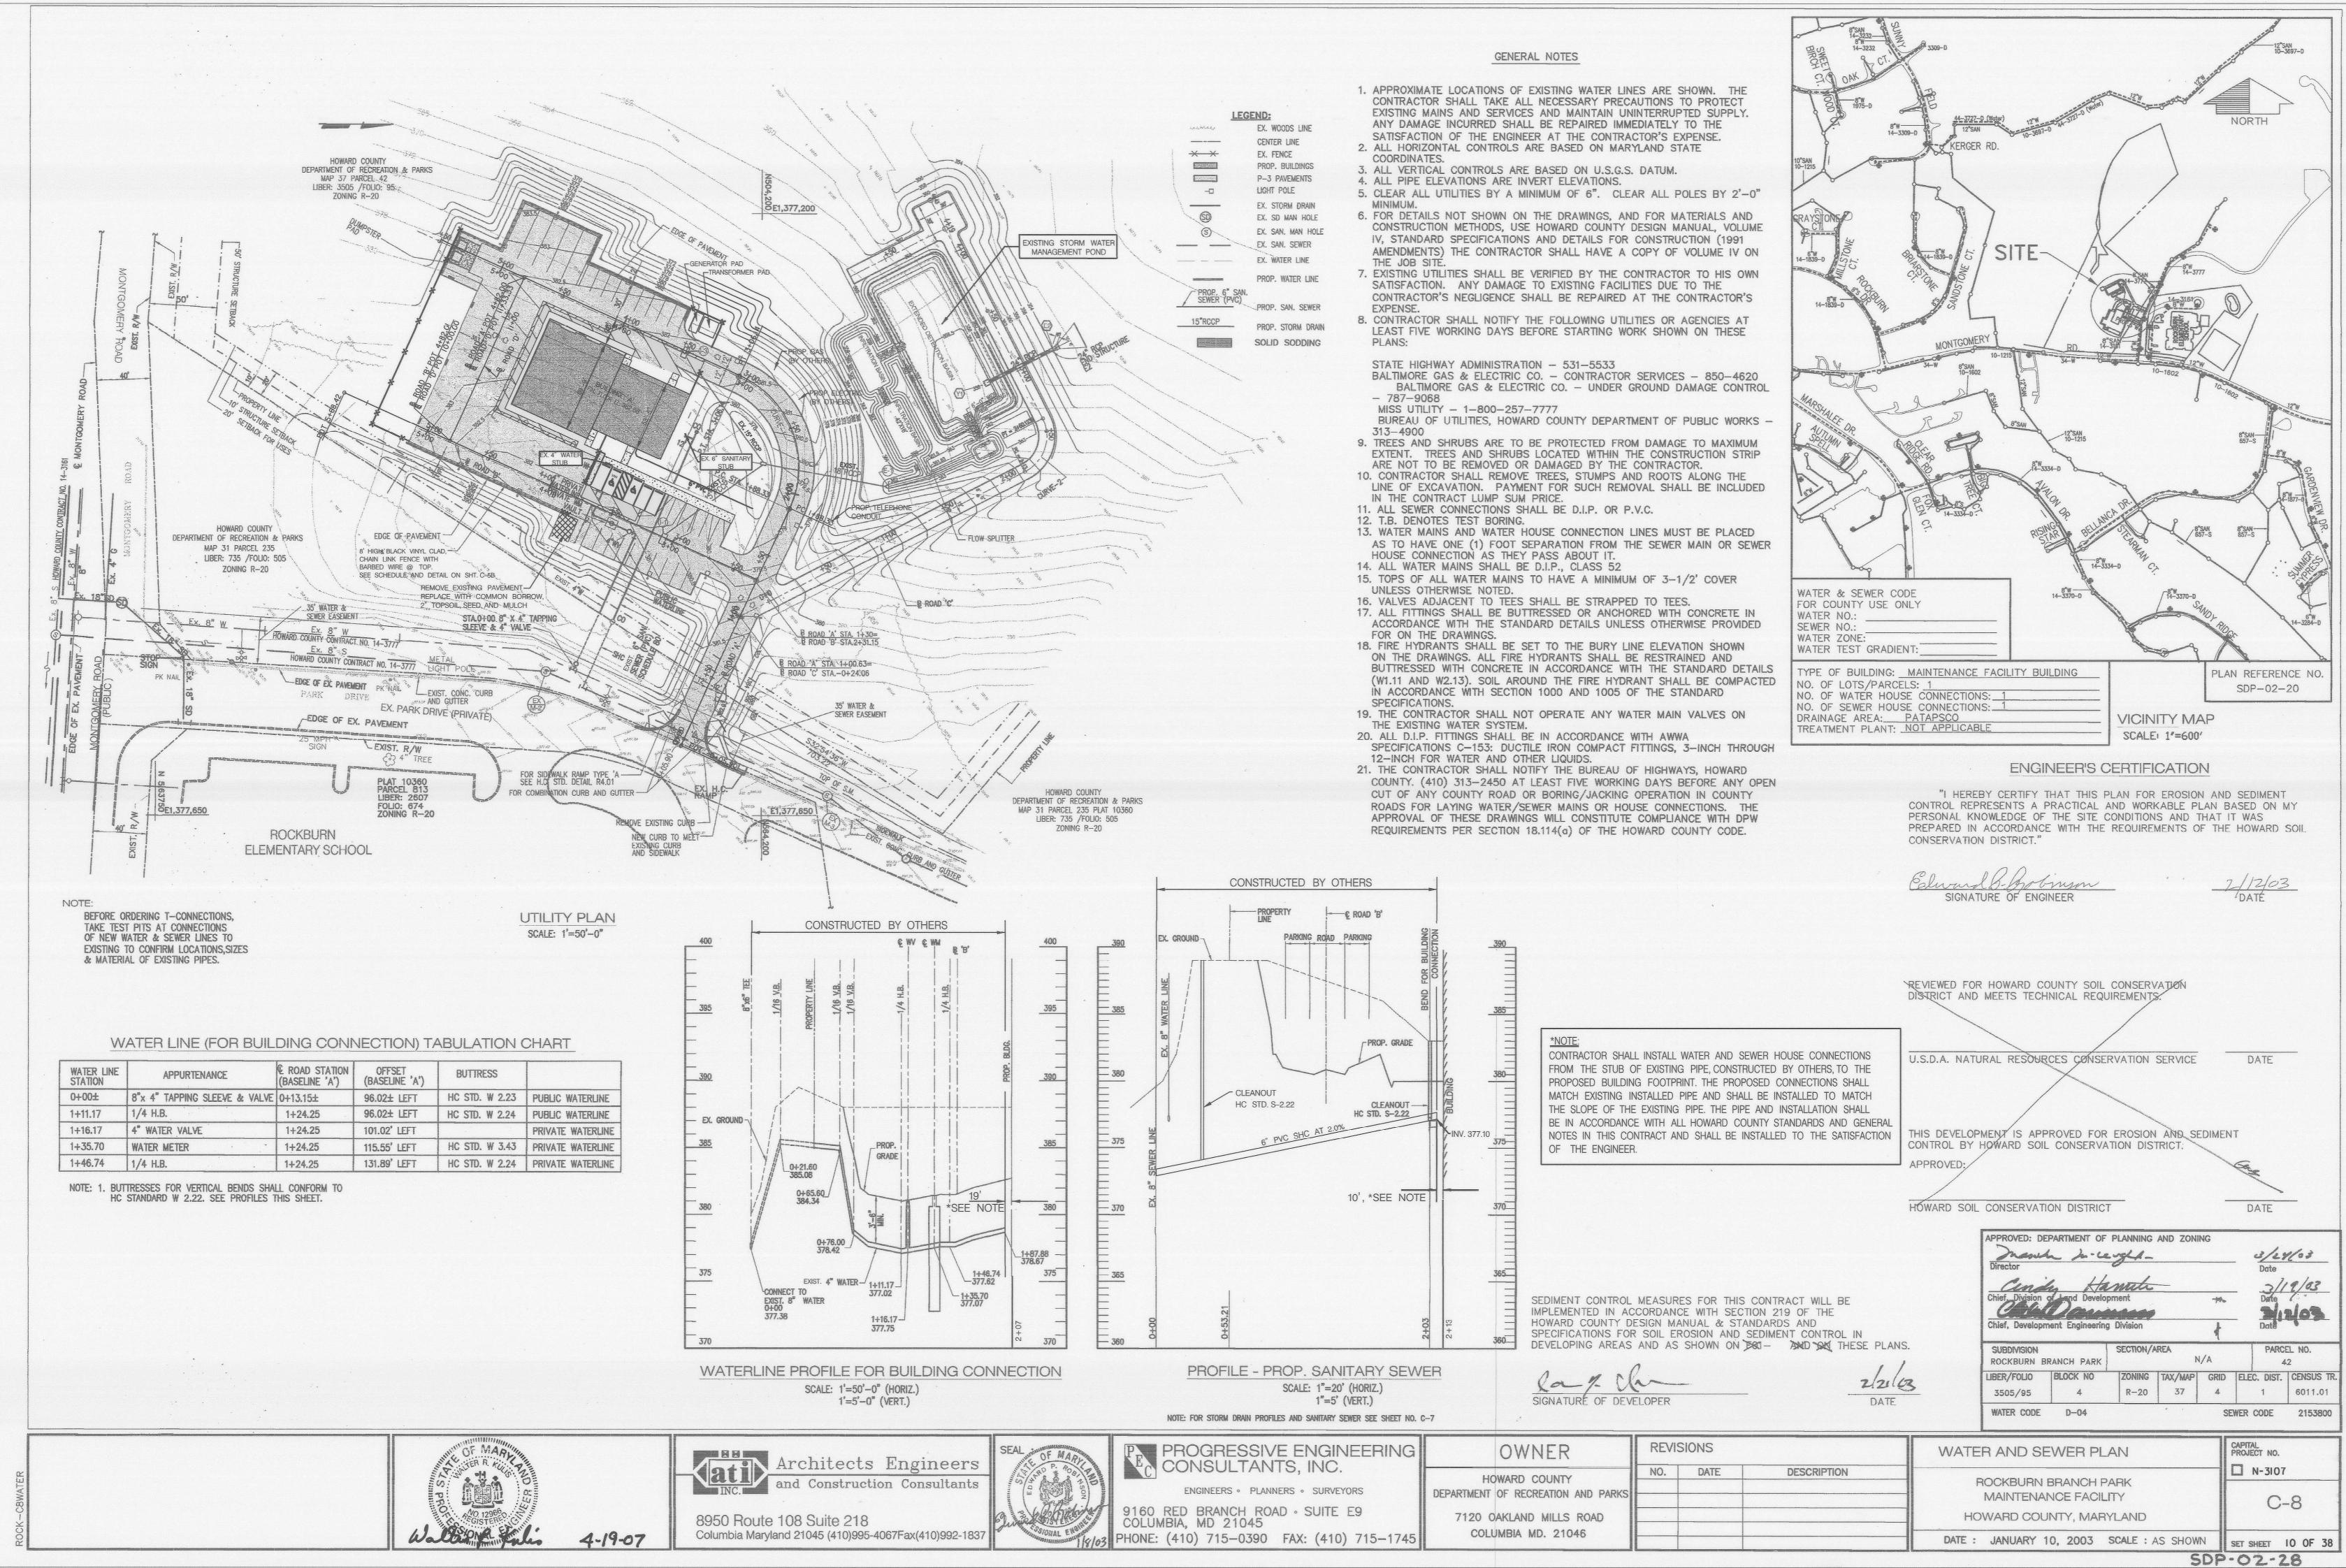

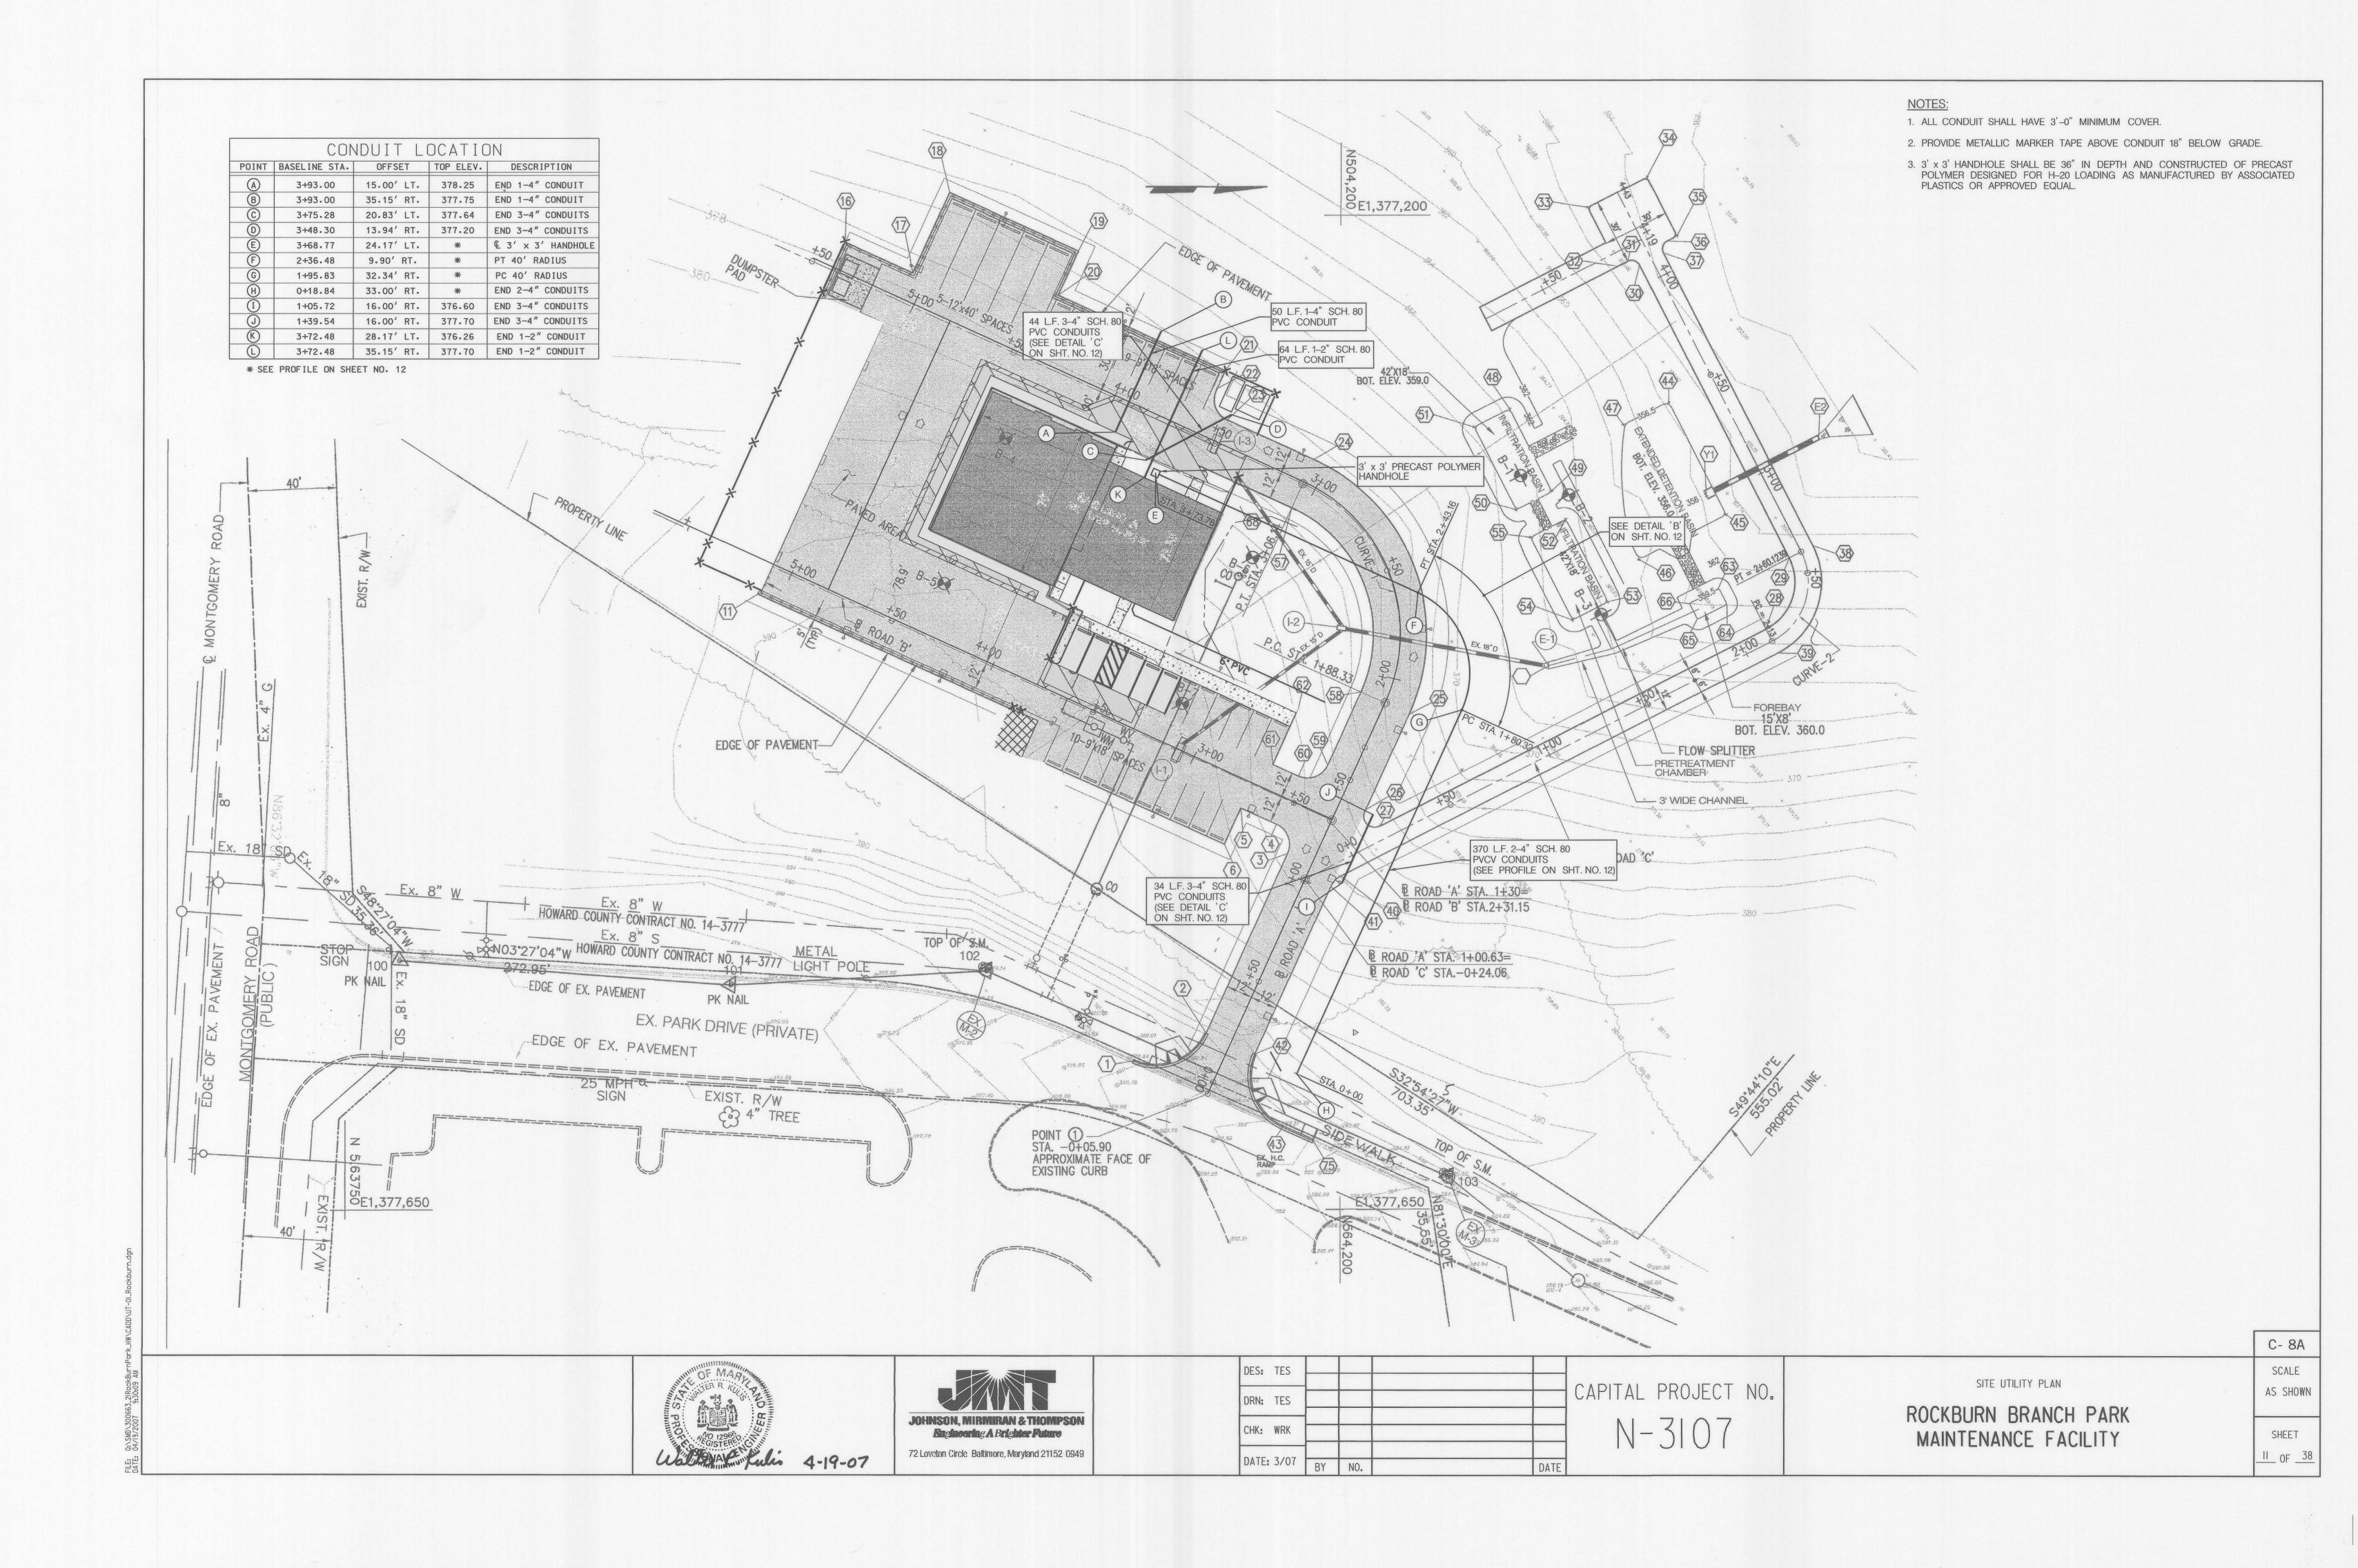


DETAIL NOTES:

- 1. TERMINATE CONDUITS WITH COUPLINGS AND PLUGS.
- 2. BENDS, UNLESS SPECIFIED BY BGE, SHALL BE NO LESS THAN 36" IN RADIUS AND LIMITED TO (1) ONE 90° CHANGE IN DIRECTION IN THE BUILDING.
- 3. ONLY STANDARD WEIGHT READY TO MIX CONCRETE WILL BE APPROVED FOR ENCASEMENT.
- 4. NO METALLIC MATERIALS (REBARS, HOLD DOWN WIRES, ETC.) SHALL BE PERMITTED IN SPACES BETWEEN LOW VOLTAGE DUCTS.
- 5. A MANDREL (1/2" SMALLER IN DIAMETER THAN THE CONDUIT AND 6" LONG) SHALL BE PULLED THROUGH EACH DUCT FOLLOWED BY A POLYOLEFIN (1,500 LB TEST) PULL-IN CORD WHICH SHALL REMAIN IN EACH DUCT.
- 6. STRENGTH OF CONCRETE ENCASEMENT SHALL BE fc 3,000 PSI MINIMUM.

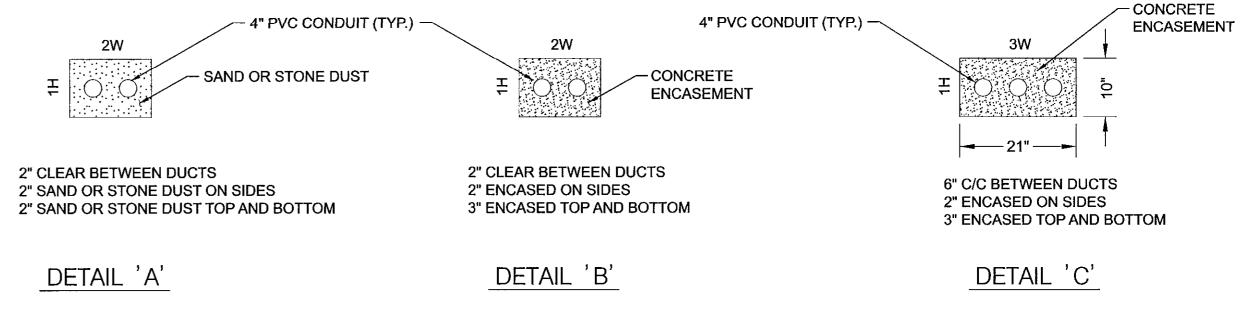


TYPICAL CONDUIT DETAILS

NOT TO SCALE

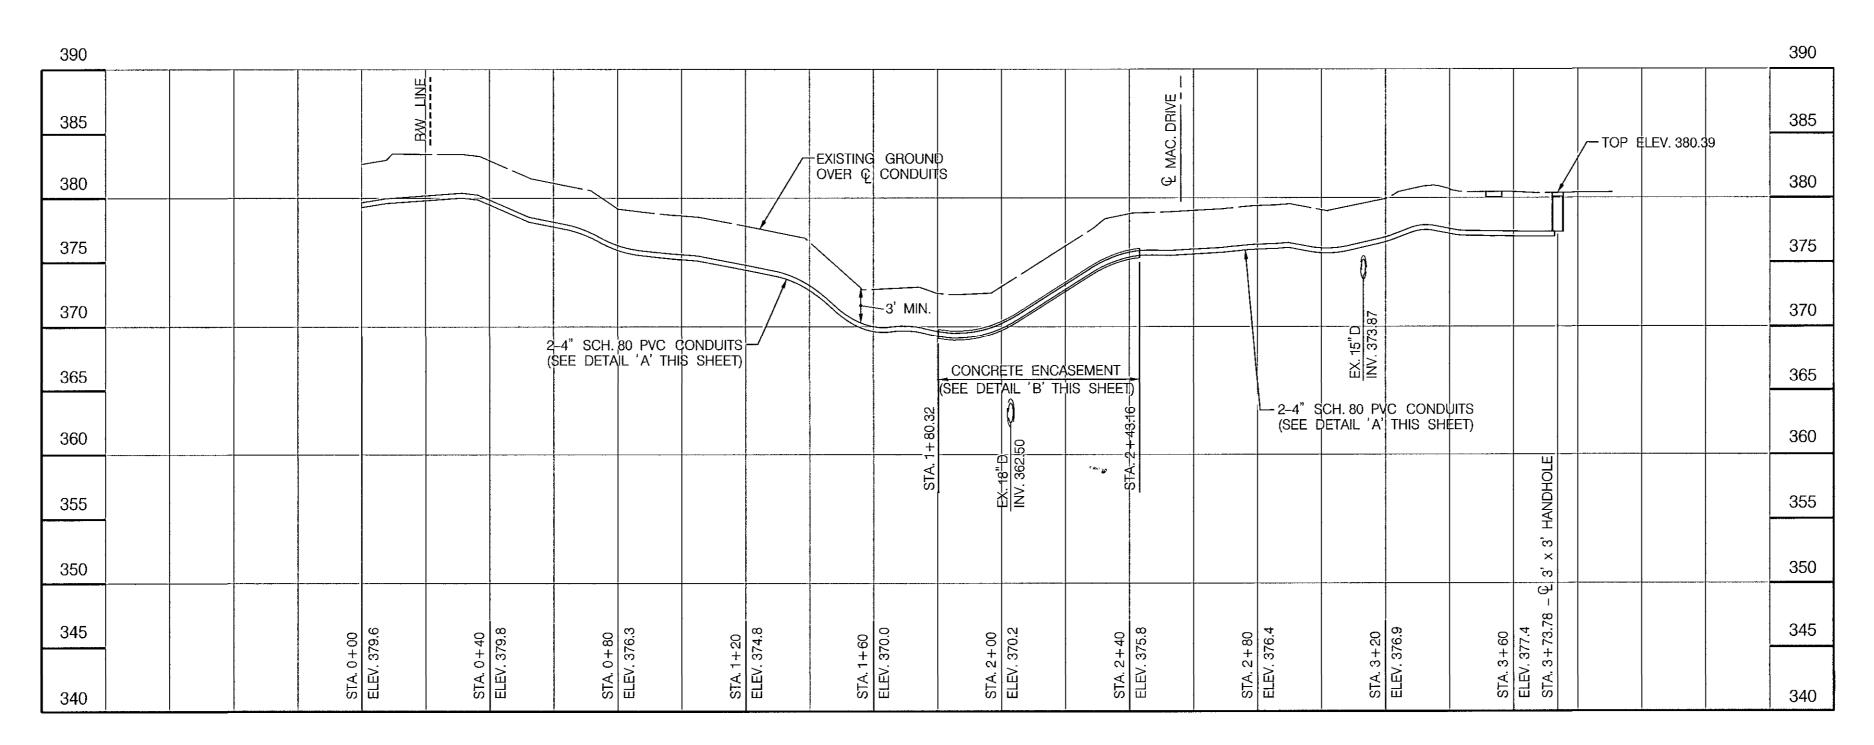

UTILITY PROFILE

SCALE: HOR: 1" = 20'
VERT. 1" = 5'

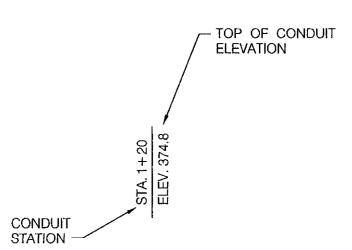





DES: TES	:			
				\sim $^{\prime}$
DRN: . TES				LA
CHK: WRK				
DATE: 3/07	BY	NO.	DATE	


CAPITAL PROJECT NO. N-3107

SITE UTILITY PROFILE AND DETAILS

ROCKBURN BRANCH PARK MAINTENANCE FACILITY

C- 8B SCALE AS SHOWN

12 OF <u>38</u>

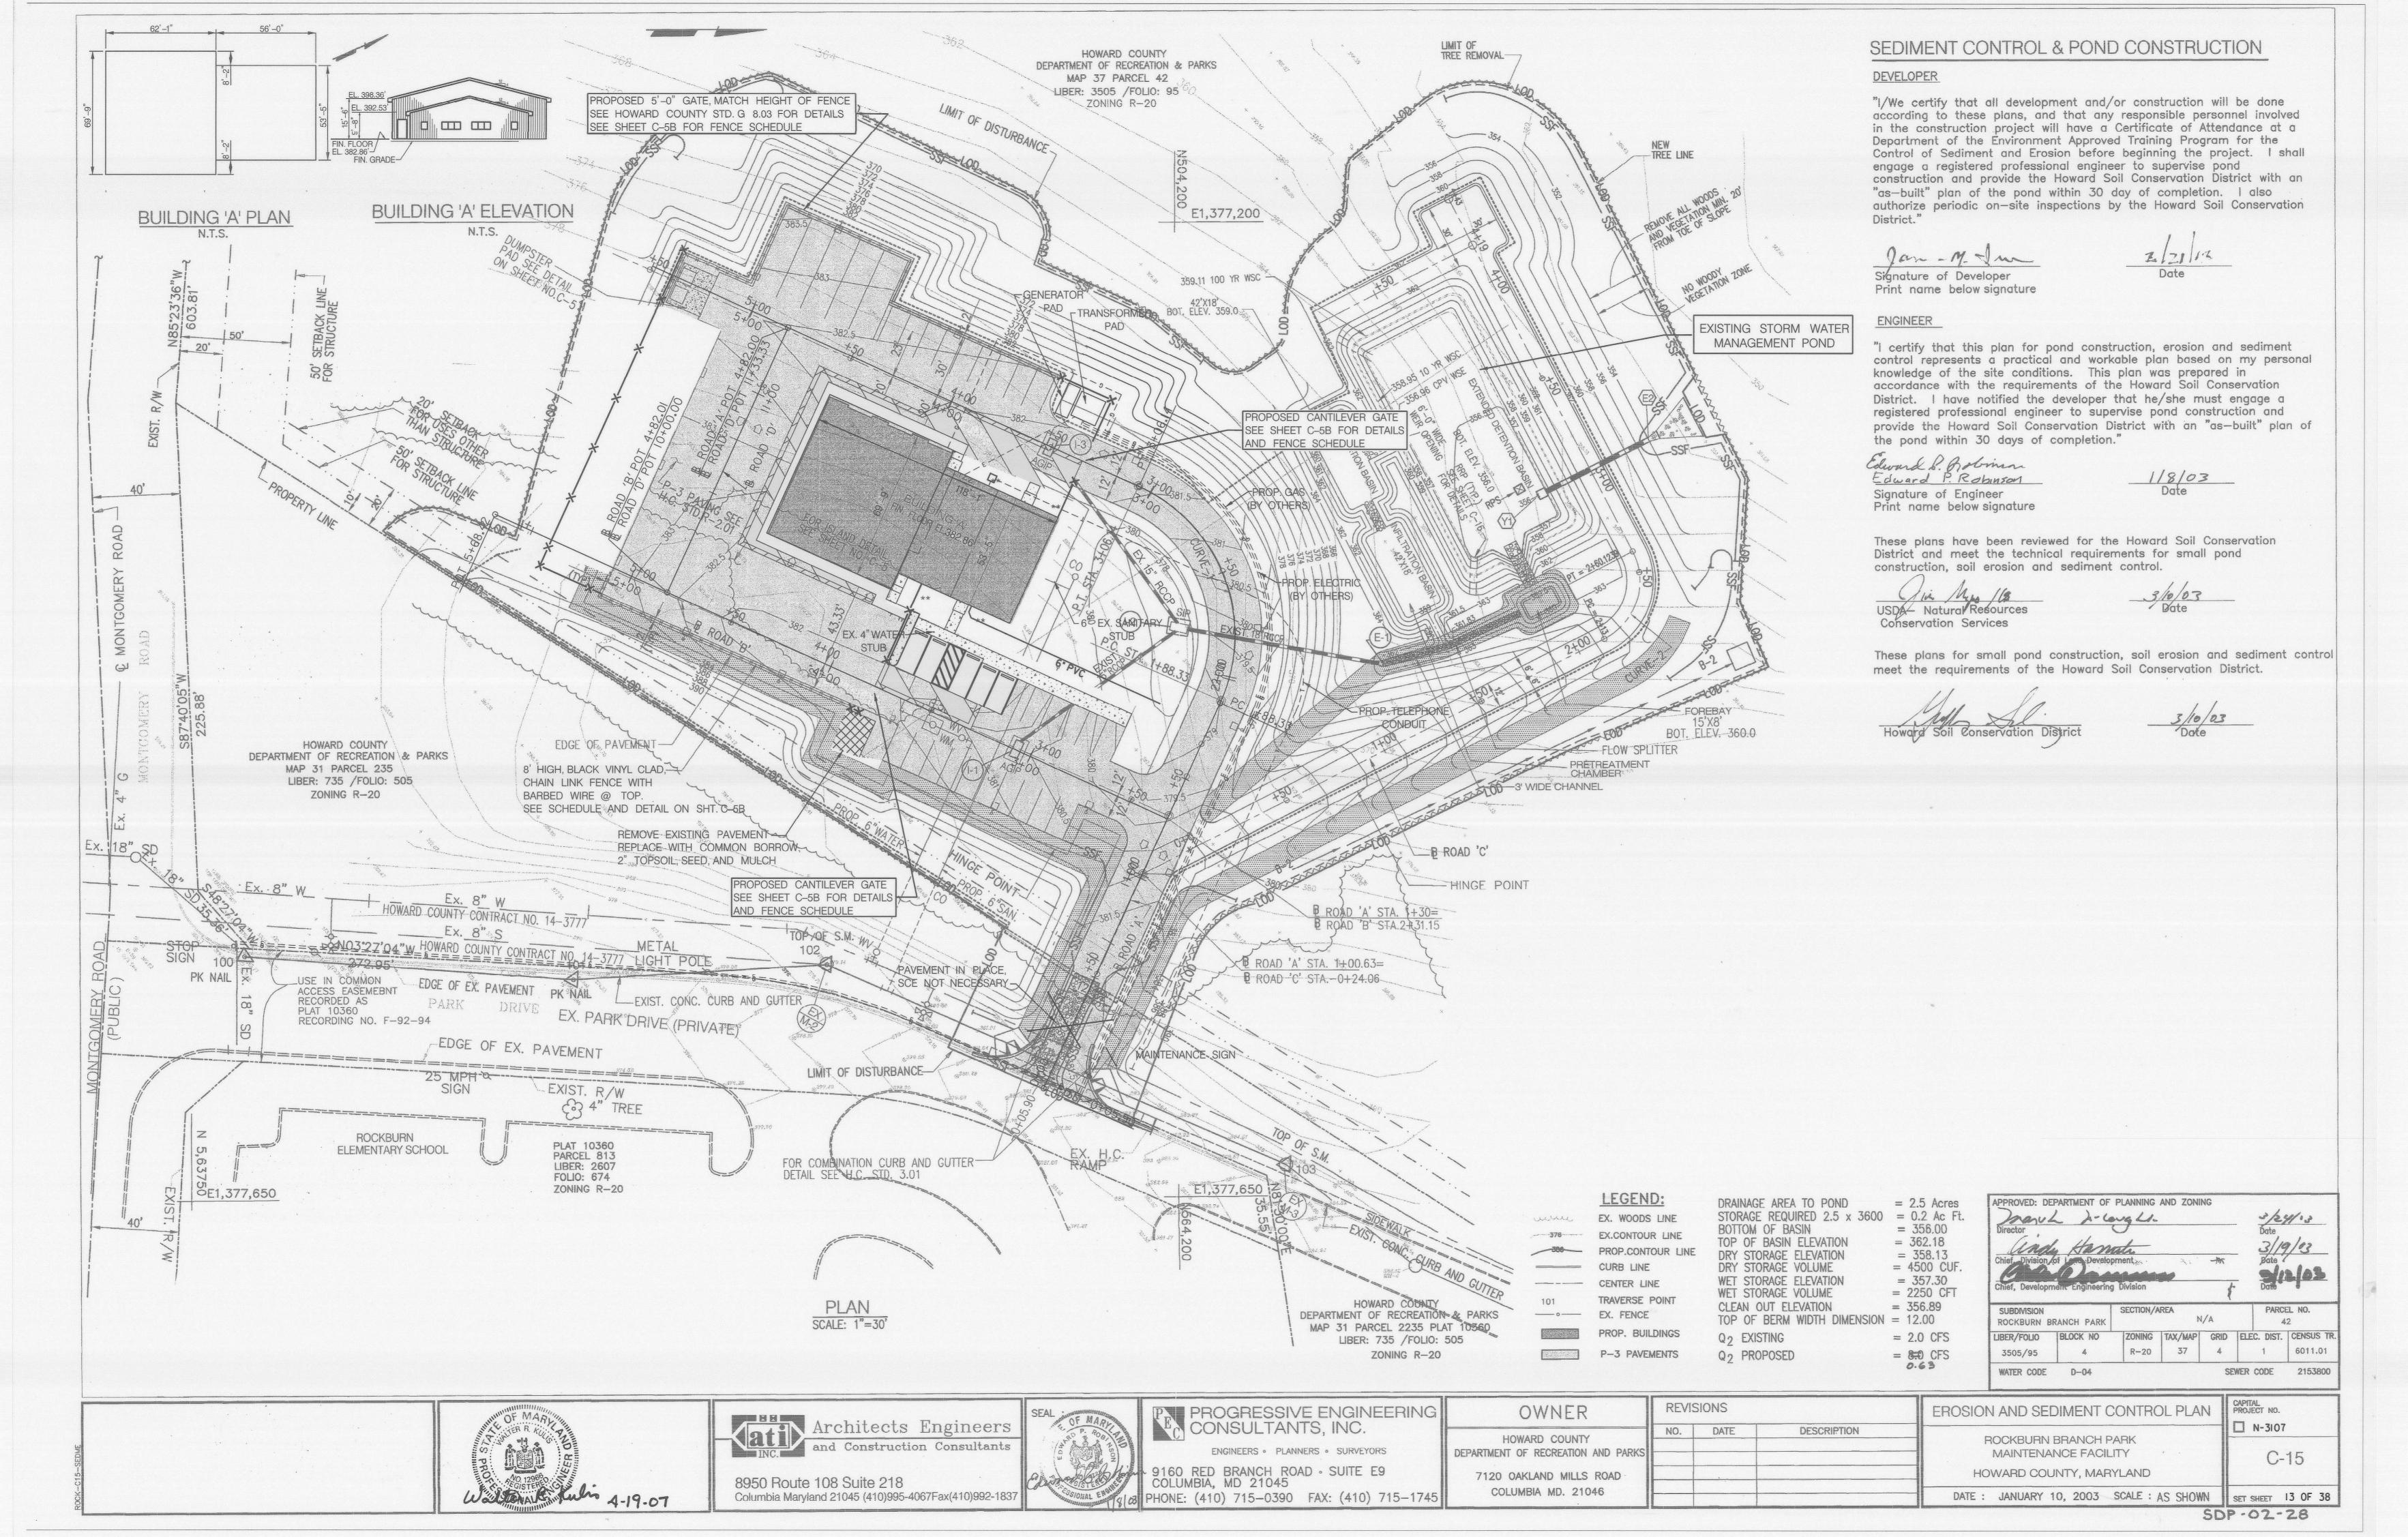

HOWARD SOIL CONSERVATION DISTRICT STANDARD SEDIMENT CONTROL NOTES

- 1. A minimum of 48 hours notice must be given to the Howard County Department of Inspections, Licenses and Permits, Sediment Control Division prior to the start of any construction (313-1855).
- 2. All vegetative and structural practices are to be installed according to the provisions to this plan and are to be in conformance with the 1994 MARYLAND STANDARDS AND SPECIFICATIONS FOR SOIL EROSION AND SEDIMENT CONTROL and revisions thereto.
- Following initial soil disturbance or re—disturbance, permanent or temporary stabilization shall be completed within: a) 7 calendar days for all perimeter sediment control structures, dikes, perimeter slopes and all slopes steeper than 3:1, b) 14 days as to all other disturbed or graded areas on the project site.
- 4. All sediment traps/basins shown must be fenced and warning signs posted around their perimeter in accordance with Vol 1, Chapter 7 of the HOWARD COUNTY DESIGN MANUAL, Storm Drainage.
- All disturbed greas must be stabilized within the time period specified above in accordance with the 1994 MARYLAND STANDARDS AND SPECIFICATIONS FOR SOIL EROSION AND SEDIMENT CONTROL for permanent seeding, sod, temporary seeding, and mulching (Sec.G). Temporary stabilization with mulch alone shall only be done when recommended seeding dates do not allow for proper germination and establishment of grasses.
- 6. All sediment control structures are to remain in place and are to be maintained in operative condition until permission for their removal has been obtained from the Howard County Sediment Control Inspector.
- 7. Site Analysis:

Total Area of Site Area Disturbed Area to be roofed or paved Area to be vegetatively stabilized Total Fill

= 22 Acres = 3.76 Acres = 1.35 Acres = 2.41 Acres = 11,226 C.Y. (Includes 15% for shrinkage)

Offsite waste/borrow area location = SITE WITH AN AN ACTIVE GRADING PERMIT 8. Any sediment control practice which is disturbed by grading activity for placement of utilities must be

- repaired on the same day of disturbance. Additional sediment control must be provided, if deemed necessary by the Howard County Sediment Control
- Inspector. 10. On all sites with disturbed areas in excess of 2 acres, approval of the inspection agency shall be requested upon completion of installation of perimeter erosion and sediment controls, but before proceeding with any other earth disturbance or grading. Other building or grading inspecting approvals may not be authorized until this initial approval by the inspecting agency is made.
- 11. Trenches for the construction of utilities is limited to three pipe lengths or that which shall be back-filled and stabilized within one working day, whichever is shorter.

TOPSOIL

Topsoil: - Topsoil salvaged from the existing site may be used provided that it meets the standards as set forth in these specifications. typically, the depth of topsoil to be salvaged for a given soil type can be found in the representative soil profile section in the Soil Survey published by USDA—SCS in cooperation with Maryland Agricultural Experimental Station. Topsoil Specifications - Soil to be used as topsoil must meet the following:

Topsoil shall be a loam, sandy loam, clay loam, silt loam, sandy clay loam, loamy sand. Other soils may be used if recommended by an agronomist or soil scientist and approved by the appropriate approval authority. Regardless, topsoil shall not be a mixture of constrasting textured subsoils and shall contain less than 5% by volume of cinders, stones, slag, coarse fragments, gravel. sticks, roots, trash or other materials larger than a 1 1/2" in diameter.

Topsoil must be free of plants or plant parts such as bermuda grass, quackgrass, Johnsongrass, nutsedge, poison ivy,

PERMANENT SEEDING NOTES

Apply to graded or cleared areas not subject to immediate further disturbance where a permanent long-lived

Seedbed Preparation: Loosen upper three inches of soil by raking, disking or other acceptable means before seeding, if not previously loosened.

Soil Amendments: In lieu of soil test recommendations, use one of the following schedules:

Preferred — Apply 2 tons/acre dolomitic limestone (92lbs/1000 sq. ft.) and 600 lbs/acre 10-10-10 fertilizer (14 lbs/1000 sq.ft.) before seeding. Harrow or disk into upper three inches of soil. At time of seeding, apply 400 lbs/acre 30-0-0 ureaform fertilizer (9 lobs/1000 sq.ft.) Acceptable - Apply 2 tons/ acre dolomitic limestone (92 lbs/1000 sq.ft.) and 1000 lbs/acre 10-10-10 fertilizer (23 lbs/1000 sq. ft) before seeding. Harrow or disk into upper three inches of soil.

Seeding — For the periods March 1 — April 30, and August 1 — October 15, seed with 60 lbs/acre (1.4 lbs/1000 sq. ft.) of Kentucky 31 Tall Fescue. For the period May 1 — July 31, seed with 60 lbs Kentucky 31 Tall Fescue per acre and 2 lbs/acre (.05 lbs/1000 sq. ft.) of weeping lovegrass. During the period of October 16 — February 28, protect site by: Option 1 — Two tons per acre of well anchored straw mulch and seed as soon as possible in the spring. Option 2 — Use sod. Option 3 — Seed with 60 lobs/acre Kentucky 30 Tall Fescue and mulch with 2 tons/acre well anchored straw.

Mulching - Apply 1-1/2 to 2 tons per acre (70 to 90 lbs/1000 sq. ft.) of unrotted small grain straw immediately after seeding. Anchor mulch immediately after application using mulch anchoring tool or 218 gallons per acre (5 gal/1000 sq. ft.) of emulsified asphalt on flat areas. On slope 8 feet or higher, use 348 gallons per acre (8 gal/1000 sq. ft.) for anchoring.

Maintenance - Inspect all seeding areas and make needed repairs, replacements and reseedings.

TEMPORARY SEEDING NOTES

Apply to graded or cleared areas likely to be re-disturbed where a short-term vegetative cover is needed.


Seedbed preparation: - Loosen upper three inches of soil by raking, disking or other acceptable means before seeding, if not previously loosened.


Soil Amendments: - Apply 600 lbs/acre 10-10-10 fertilizer (14lbs/1000 sq. ft.)

Seeding: — For periods March 1 — April 30 and from August 15 — October 15, seed with 2—1/2 bushel per acre of annual rye (3.2 lbs/1000 sq.ft.). For the period May 1 — August 14, seed with 3 lbs/acre of weeping lovegrass (.07 lbs/1000 sq. ft.). For the period November 16 — February 18, protect site by applying 2 tons/acre of well anchored straw mulch and seed as soon as possible in the spring, or use sod.

Mulching: - Apply 1-1/2 to 2 tons/acre (70 to 90 lbs/1000 sq.ft.) of unrotted weed-free, small grain straw immediately after seeding. Anchor mulch immediately after application using mulch anchoring tool or 218 gal. per acre (5 gal/1000 sq. ft.) of emulsified asphalt on flat areas. On slope 8 ft. or higher, use 348 gal. per acre (8 gal/1000 sq. ft.) for anchoring.

Refer to the 1994 MARYLAND STANDARDS AND SPECIFICATIONS FOR SOIL EROSION AND SEDIMENT CONTROL additional rates and methods not covered.

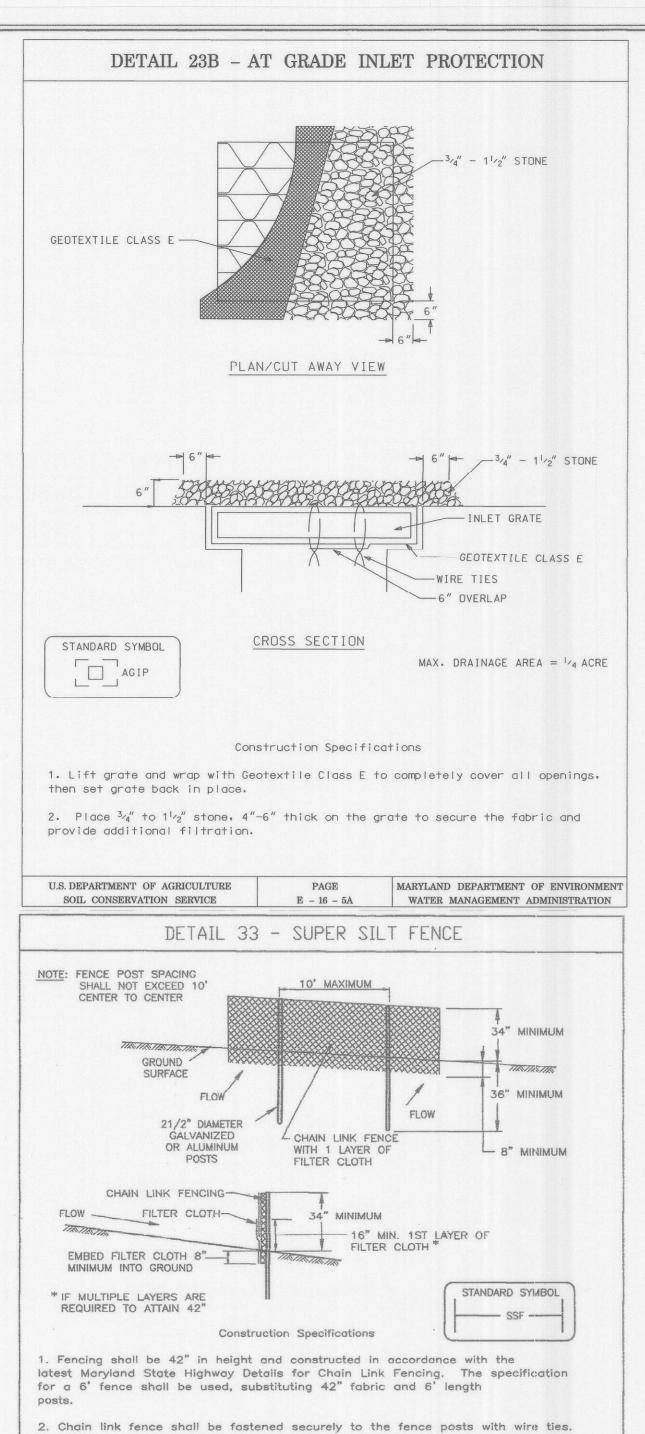

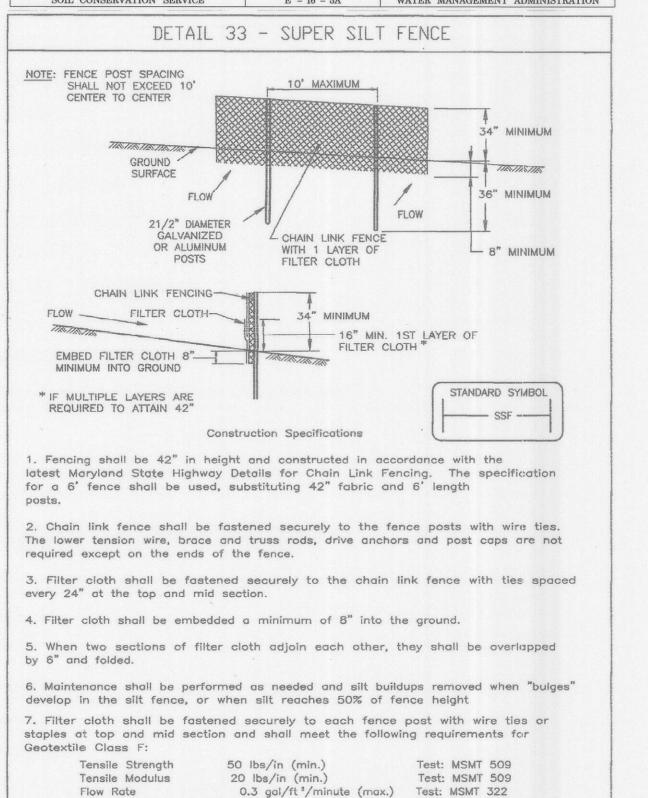

SEDIMENT CONTROL & POND CONSTRUCTION

DEVELOPER

"I/We certify that all development and/or construction will be done according to these plans, and that any responsible personnel involved in the construction project will have a Certificate of Attendance at a Department of the Environment Approved Training Program for the Control of Sediment and Erosion before beginning the project. I shall engage a registered professional engineer to supervise pond construction and provide the Howard Soil Conservation District with an "as-built" plan of the pond within 30 day of completion. I also authorize periodic on-site inspections by the Howard Soil Conservation District."

Jan 7anature of Developer Print name below signature 2 21 03

ENGINEER

"I certify that this plan for pond construction, erosion and sediment control represents a practical and workable plan based on my personal knowledge of the site conditions. This plan was prepared in accordance with the requirements of the Howard Soil Conservation District. I have notified the developer that he/she must engage a registered professional engineer to supervise pond construction and provide the Howard Soil Conservation District with an "as-built" plan of the pond within 30 days of completion."

Signature of Engineer Print name below signature


These plans have been reviewed for the Howard Soil Conservation District and meet the technical requirements for small pond construction, soil erosion and sediment control.

Jin /ligro / USDA / Natural Résources Conservation Services

These plans for small pond construction, soil erosion and sediment control meet the requirements of the Howard Soil Conservation District.

SEQUENCE OF CONSTRUCTION

- 1 OBTAIN PROPER PERMITS, NOTIFY HOWARD COUNTY DEPARTMENT OF PERMITS, SEDIMENT CONTROL DIVISION REPRESENATIVE AS PER NOTE 1 OF SEDIMENT CONTROL NOTES.
- 2 AFTER RECEIVING PERMISSION FROM INSPECTOR TO PROCEED, INSTALL ALL REQUIRED
- EROSION AND SEDIMENT CONTROL FACILITIES.
- 3 INSTALL TEMPORARY CHAIN-LINK FENCE AND GATES TO SECURE SITE. 4 INSTALL UNDERGROUND ELECTRIC, GAS, AND COMMUNICATIONS CONDUITS; AND EXTENSION
- OF THE WATER AND SEWER HOUSE CONNECTIONS TO CONNECTION POINT WITH BUILDING.
- 5 GRADE BUILDING TO SUBGRADE LEVEL. 6 CONSTRUCT FOUNDATION FOR BUILDING
- 7 CONSTRUCT TRANSFORMER AND GENERATOR PAD INCLUDING GRADING; AND INSTALL
- TRANSFORMER, GENERATOR, AND RELATED EQUIPMENT
- 8 CONSTRUCT MAINTENANCE BUILDING AS WORK PROGRESSES ON OTHER FEATURES OF PROJECTS. 9 PLACE GRANULAR SUBBASE MATERIAL AND ASPHALTIC BASE COURSE ON ROAD 'A' AND
- PARKING LOT WHERE PROP. FULL DEPTH PAVEMENT IS REQUIRED. WEDGE/LEVEL PAVEMENT 10 GRADE ROAD 'B' TO SUBGRADE AND PLACE GRANULAR SUBBASE AND ASPHALTIC BASE
- COURSE WHERE PROP. FULL DEPTH PAVEMENT IS REQUIRED. WEDGE/LEVEL PAVEMENT WHERE REQUIRED.
- 11 INSTALL SITE UTILITIES FOR SITE LIGHTING AND PROPOSED ENTRANCE SIGN
- 12 INSTALL PROPOSED CONCRETE SIDEWALKS AND ISLAND.
- 13 INSTALL LIGHTING POLES AND FIXTURES
- 14 LAY PAVEMENT SURFACE COURSE FOR ROADS AND PARKING LOT.
- 15 CONSTRUCT FENCE AND GATES
- 16 REMOVE TEMPORARY CHAIN-LINK FENCE AND GATES.
- 17 PROVIDE PERMANENT SEEDING AND MULCHING.
- 18 REMOVE EROSION AND SEDIMENT CONTROL FACILITIES WITH CONCURRENCE OF COUNTY.

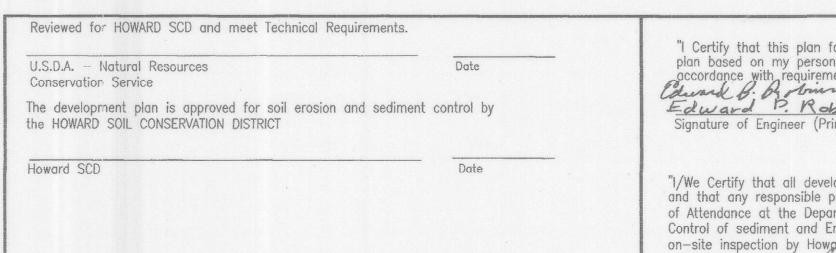

ENGINEER'S CERTIFICATE "I Certify that this plan for erosion and sediment control represents a practical and workable plan based on my personal knowledge of the site conditions and that it was prepared in accordance with requirements of the Howard Soil Conservation District."

Edward P. Robinson 1/8/03 Date Signature of Engineer (Print name below signature)

DEVELOPER'S CERTIFICATE

"I/We Certify that all development and construction will be done according to this plan and that any responsible personal involved in the construction project will have a certificate of Attendance at the Department of the Environment Approved Training Program for the Control of sediment and Erosion before beginning the project. I also authorize periodic on-site inspection by Howard Soil Conservation District" ane M. Tu 212/163

3/2/03 SECTION/AREA PARCEL NO. N/A ROCKBURN BRANCH PARK ELEC. DIST. CENSUS LIBER/FOLIO BLOCK NO ZONING TAX/MAP GRID R-20 6011.01 3505/95 WATER CODE D-04 SEWER CODE 2153800

PROJECT NO.


☐ N-3107

SDP-02-28

C-16

SET SHEET 14 OF 38

APPROVED: DEPARTMENT OF PLANNING AND ZONING

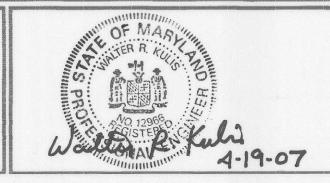

Architects Engineers and Construction Consultants

Columbia Maryland 21045 (410)995-4067Fax(410)992-1837

8950 Route 108 Suite 218

Filtering Efficiency 75% (min.)

Test: MSMT 322

PROGRESSIVE ENGINEERING CONSULTANTS, INC. ENGINEERS · PLANNERS · SURVEYORS

9160 RED BRANCH ROAD · SUITE E9 COLUMBIA, MD 21045 PHONE: (410) 715-0390 FAX: (410) 715-1745

HOWARD COUNTY DEPARTMENT OF RECREATION AND PARKS 7120 OAKLAND MILLS ROAD COLUMBIA MD. 21046

Signature of Developer (Print name below signature) Date REVISIONS **EROSION AND SEDIMENT CONTROL** OWNER NOTES AND DETAILS -NO. DATE DESCRIPTION ROCKBURN BRANCH PARK MAINTENANCE FACILITY HOWARD COUNTY, MARYLAND DATE: JANUARY 10, 2003 SCALE

	BASELINE ROAD 'A' CONTROL POINTS AND ELEVATIONS									
STATION	POINT #	OFFSET	FINISHED ELEVATION	REMARKS	EXIST. ELEV.					
3+33.92	68	28.17′, LT.	382.69	GRADE AT CORNER OF BUILDING	381.85					
3+35.13		18.25′, LT.	382.18	EDGE OF PAVEMENT	381.75					
3+40.00		18.37′, LT.	382.42	EDGE OF PAVEMENT	381.79					
3+47.21		18.56', LT.	382.55	EDGE OF PAVEMENT /SIDEWALK	381.84					
3+47.21		23.17′, LT.	382.76	SIDEWALK GRADE BREAK	381.55					
3+46.87		23.17′, LT.	382.76	CORNER OF SIDEWALK	381.55					
3+46.87		28.17′, LT.	382.86	BUILDING /SIDEWALK	381.57					
3+50.00		18.63′, LT.	382.53	PAVEMENT /SIDEWALK	381.86					
3+50.00		23.17′, LT.	382.76	SIDEWALK GRADE BREAK	381.56					
3+50.00		28.17′, LT.	382.86	BUILDING /SIDEWALK	381.58					
3+52.21		18.69', LT.	382.56	EDGE OF PAVEMENT /SIDEWALK	381.88					
3+52.21		23.17′, LT.	382.76	SIDEWALK GRADE BREAK	381.56					
3+52.54		23.17′, LT.	382.76	CORNER OF SIDEWALK	381.56					
3+52.54		28.17′, LT.	382.86	BUILDING /SIDEWALK	381.58					
3+60.00		18.89′, LT.	382.42	EDGE OF PAVEMENT	381.94					
3+70.00		19.14′, LT.	382.44	EDGE OF PAVEMENT	382.02					
3+80.00		19.40′, LT.	382.46	EDGE OF PAVEMENT	382.10					
3+84.92		20.00′, LT.	382.60	EDGE OF SIDEWALK /PAVEMENT	381.70					
3+84.92		23.17′, LT.	382.76	SIDEWALK GRADE BREAK	381.56					
3+84.12		23.17′, LT.	382.76	CORNER OF SIDEWALK	381.56					
3+84.12		28.17′, LT.	382.86	BUILDING /SIDEWALK	381.56					
3+89.92	56	20.00′, LT.	382.69	EDGE OF SIDEWALK /PAVEMENT	381.72					
3+89.92		23.17′, LT.	382.76	SIDEWALK GRADE BREAK	381.59					
3+89.92		28.17′, LT.	382.86	CORNER OF BUILDING /SIDEWALK	381.54					
4+52.00	67	20.00′, LT.	382.69	CORNER OF BUILDING /EDGE OF PAVEMENT	382.17					

BASELINE ROAD 'D' CONTROL POINTS AND ELEVATIONS										
STATION POINT OFFSET		OFFSET	FINISHED ELEVATION	REMARKS	EXIST. ELEV.					
10 + 50.00		30.00′, RT.	382.84	EDGE OF PAVEMENT	382.49					
10+60.00		30.00′, RT.	383.08	EDGE OF PAVEMENT	382.62					
10+70.00		30.00′, RT.	383.32	EDGE OF PAVEMENT	382.76					
10+78.50		30.00′, RT.	383.53	EDGE OF PAVEMENT, HIGH POINT	382.84					
10+80.00		30.00′, RT.	383.49	EDGE OF PAVEMENT	382.82					
10+90.00		30.00′, RT.	383.25	EDGE OF PAVEMENT	382.54					
11+00.00		30.00′, RT.	383.01	EDGE OF PAVEMENT	382.26					
11+10.00		30.00′, RT.	382.77	EDGE OF PAVEMENT	382.05					

BASELINE ROAD 'B' CONTROL POINTS AND ELEVATIONS

STATION	POINT #	OFFSET	FINISHED ELEVATION	REMARKS	EXIST. ELEV.
3+20.00		12.00′, RT.	381.05	MEET EXIST PAVEMENT	380.93
3+20.00		30.25′, RT.	381.77	EDGE OF SIDEWALK /PAVEMENT	381.65
3+20.00		37.00′, RT.	381.91	EDGE OF SIDEWALK	381.79
3+30.00		12.00′, RT.	381.41	PAVEMENT BREAK	381.28
3+30.00		30.25′, RT.	381.88	EDGE OF SIDEWALK /PAVEMENT	382.13
3+30.00		37.00′, RT.	382.02	EDGE OF SIDEWALK	382.19
3+33.92	69	51.75′, RT.	382.69	GRADE AT CORNER OF BUILDING	381.89
3+38.00		12.00′, RT.	381.65	PAVEMENT BREAK	381.50
3+38.00		30.25′, RT.	382.02	EDGE OF SIDEWALK /PAVEMENT	382.39
3+38.00		32.00′, RT.	382.05	EDGE OF SIDEWALK /PAVEMENT	381.74
3+38.00		37.00′, RT.	382.15	EDGE OF SIDEWALK	381.89
3+54.80		12.00′, RT.	381.82	PAVEMENT BREAK	381.52
3+54.80		32.00′, RT.	382.22	EDGE OF SIDEWALK /PAVEMENT	381.49
3+54.80		37.00′, RT.	382.32	EDGE OF SIDEWALK	381.70
3+54.80		46.75′, RT.	382.76	SIDEWALK GRADE BREAK	381.83
3+54.47		46.75′, RT.	382.76	CORNER OF SIDEWALK	381.83
3+54.47		51.75′, RT.	382.86	BUILDING /SIDEWALK	381.82
3+59.80		12.00′, RT.	381.82	PAVEMENT BREAK	381.60
3+59.80		32.00′, RT.	382.22	EDGE OF SIDEWALK /PAVEMENT	381.59
3+59.80	:	37.00′, RT.	382.32	EDGE OF SIDEWALK	381.71
3+59.80		46.75', RT.	382.76	SIDEWALK GRADE BREAK	381.82
3+60.14		46.75′, RT.	382.76	CORNER OF SIDEWALK	381.82
3+60.14		51.75′, RT.	382.86	BUILDING /SIDEWALK	381.80
3+64.00		12.00′, RT.	381.82	PAVEMENT BREAK	381.66
3+64.00		32.00′,RT.	382.22	EDGE OF SIDEWALK /PAVEMENT	381.67
3+73.00		14.00, RT.	381.91	PC OF MONOLITHIC CONC. MEDIAN	381.80
3+73.00		32.00, RT.	382.27	EDGE OF SIDEWALK /PAVEMENT	382.25
3+73.00		37.00, RT.	382.37	EDGE OF SIDEWALK	381.90
3+73.00		38.58, RT.	382.40	EDGE OF MONOLITHIC CONC. MEDIAN	381.88
3+75.00	_,,	12.00′,RT.	381.88	MIDPOINT OF FILLET	381.75
3+75.00		38.58′,RT.	382.43	EDGE OF MONOLITHIC CONC. MEDIAN	381.90
3+77.00		14.00′,RT.	381.95	PT OF MONOLITHIC CONC. MEDIAN	381.82
3+77.00		38.58′,RT.	382.43	EDGE OF PAVEMENT /MONOLITHIC CONC. MEDIAN	381.93
3+78.00		12.00, RT.	381.90	MEET EXISTING PAVEMENT	381.77
3+78.00		33.58, RT.	382.40	MEET EXISTING PAVEMENT	382.27
3+84.92		38.58′, RT.	382.50	EDGE OF SIDEWALK /PAVEMENT	382.05
3+84.92		43.58′, RT.	382.70	SIDEWALK GRADE BREAK	381.94
3+84.92		46.41′,RT.	382.76	SIDEWALK GRADE BREAK	381.88
3+84.92		51.75′, RT.	382.76	BUILDING /SIDEWALK	381.82
3+89.92		38.58′,RT.	382.58	EDGE OF SIDEWALK /PAVEMENT /BUILDING	382.13
3+89.92		43.58′, RT.	382.80	EDGE OF SIDEWALK /PAVEMENT	382.01
3+89.92		46.41′,RT.	382.86	SIDEWALK GRADE BREAK	381.95
3+89.92		51.75′,RT.	382.86	CORNER OF BUILDING /SIDEWALK	381.85
3+94.93		33.58′,RT.	382.49	CORNER OF SAW CUT	382.36
4+52.00	70	43.58′,RT.	382.69	CORNER OF BUILDING /EDGE OF PAVEMENT	382.40

JOHNSON, MIRMIRAN & THOMPSON
Engineering A Brighter Future

72 Loveton Circle Baltimore, Maryland 21152-0949



14.	DES: SER				
H OWNERS	DRN: CWW				
47.					
Ti.	CHK: WRK DATE: 4/07				
19-07	DATE: 4/07	BY	NO.	DATE	

CAPITAL PROJECT NO.


N-3107


ROCKBURN BRANCH PARK MAINTENANCE FACILITY

C- 18

SCALE

NONE

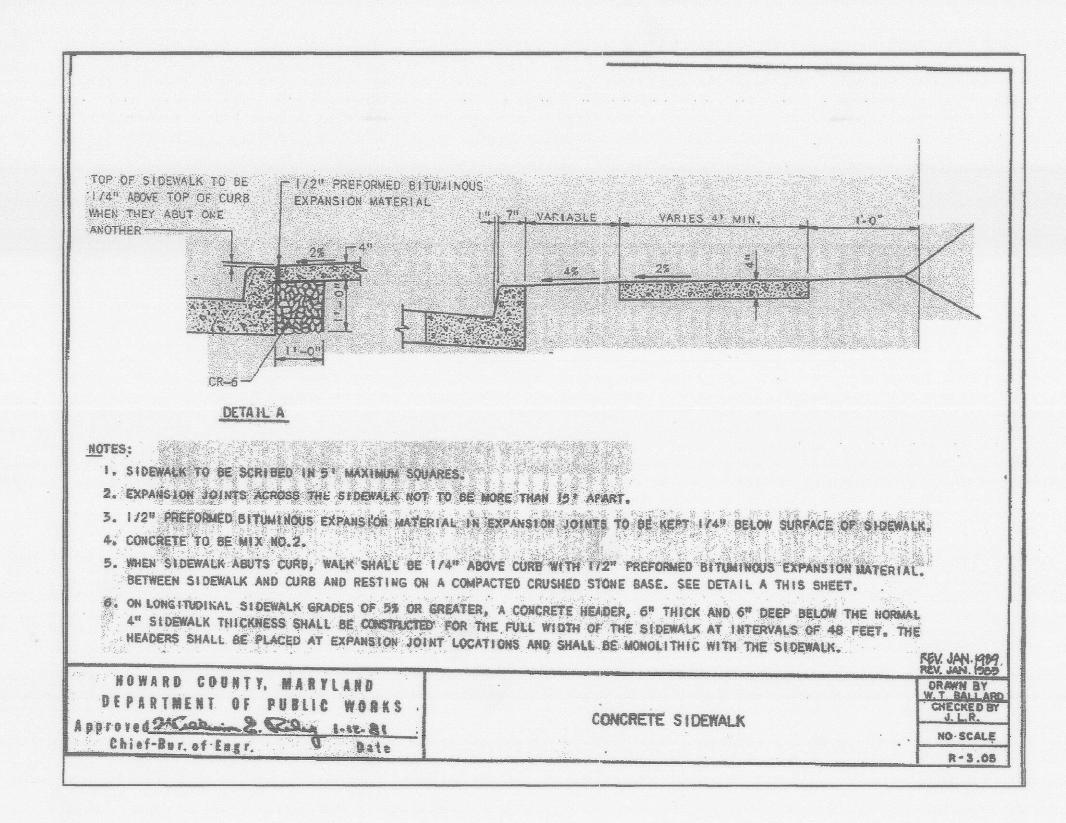

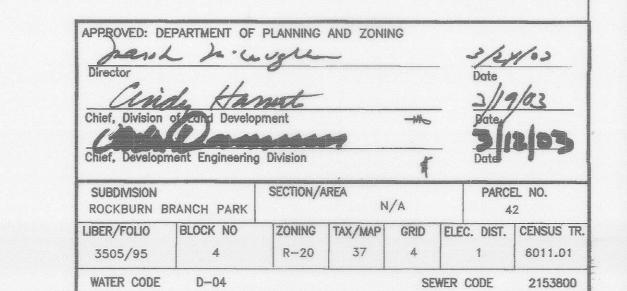





Columbia Maryland 21045 (410)995-4067Fax(410)992-1837

8950 Route 108 Suite 218



ENGINEERS · PLANNERS · SURVEYORS

HOWARD COUNTY DEPARTMENT OF RECREATION AND PARKS 7120 OAKLAND MILLS ROAD

OWNER


COLUMBIA MD. 21046


REVISIONS NO. DATE DESCRIPTION


HOWARD COUNTY STANDARD DETAILS CAPITAL PROJECT NO. □ N-3107 ROCKBURN BRANCH PARK MAINTENANCE FACILITY HOWARD COUNTY, MARYLAND


C-19 DATE: JANUARY 10, 2003 SCALE: NONE


SET SHEET 16 OF 38 SDP-02-28

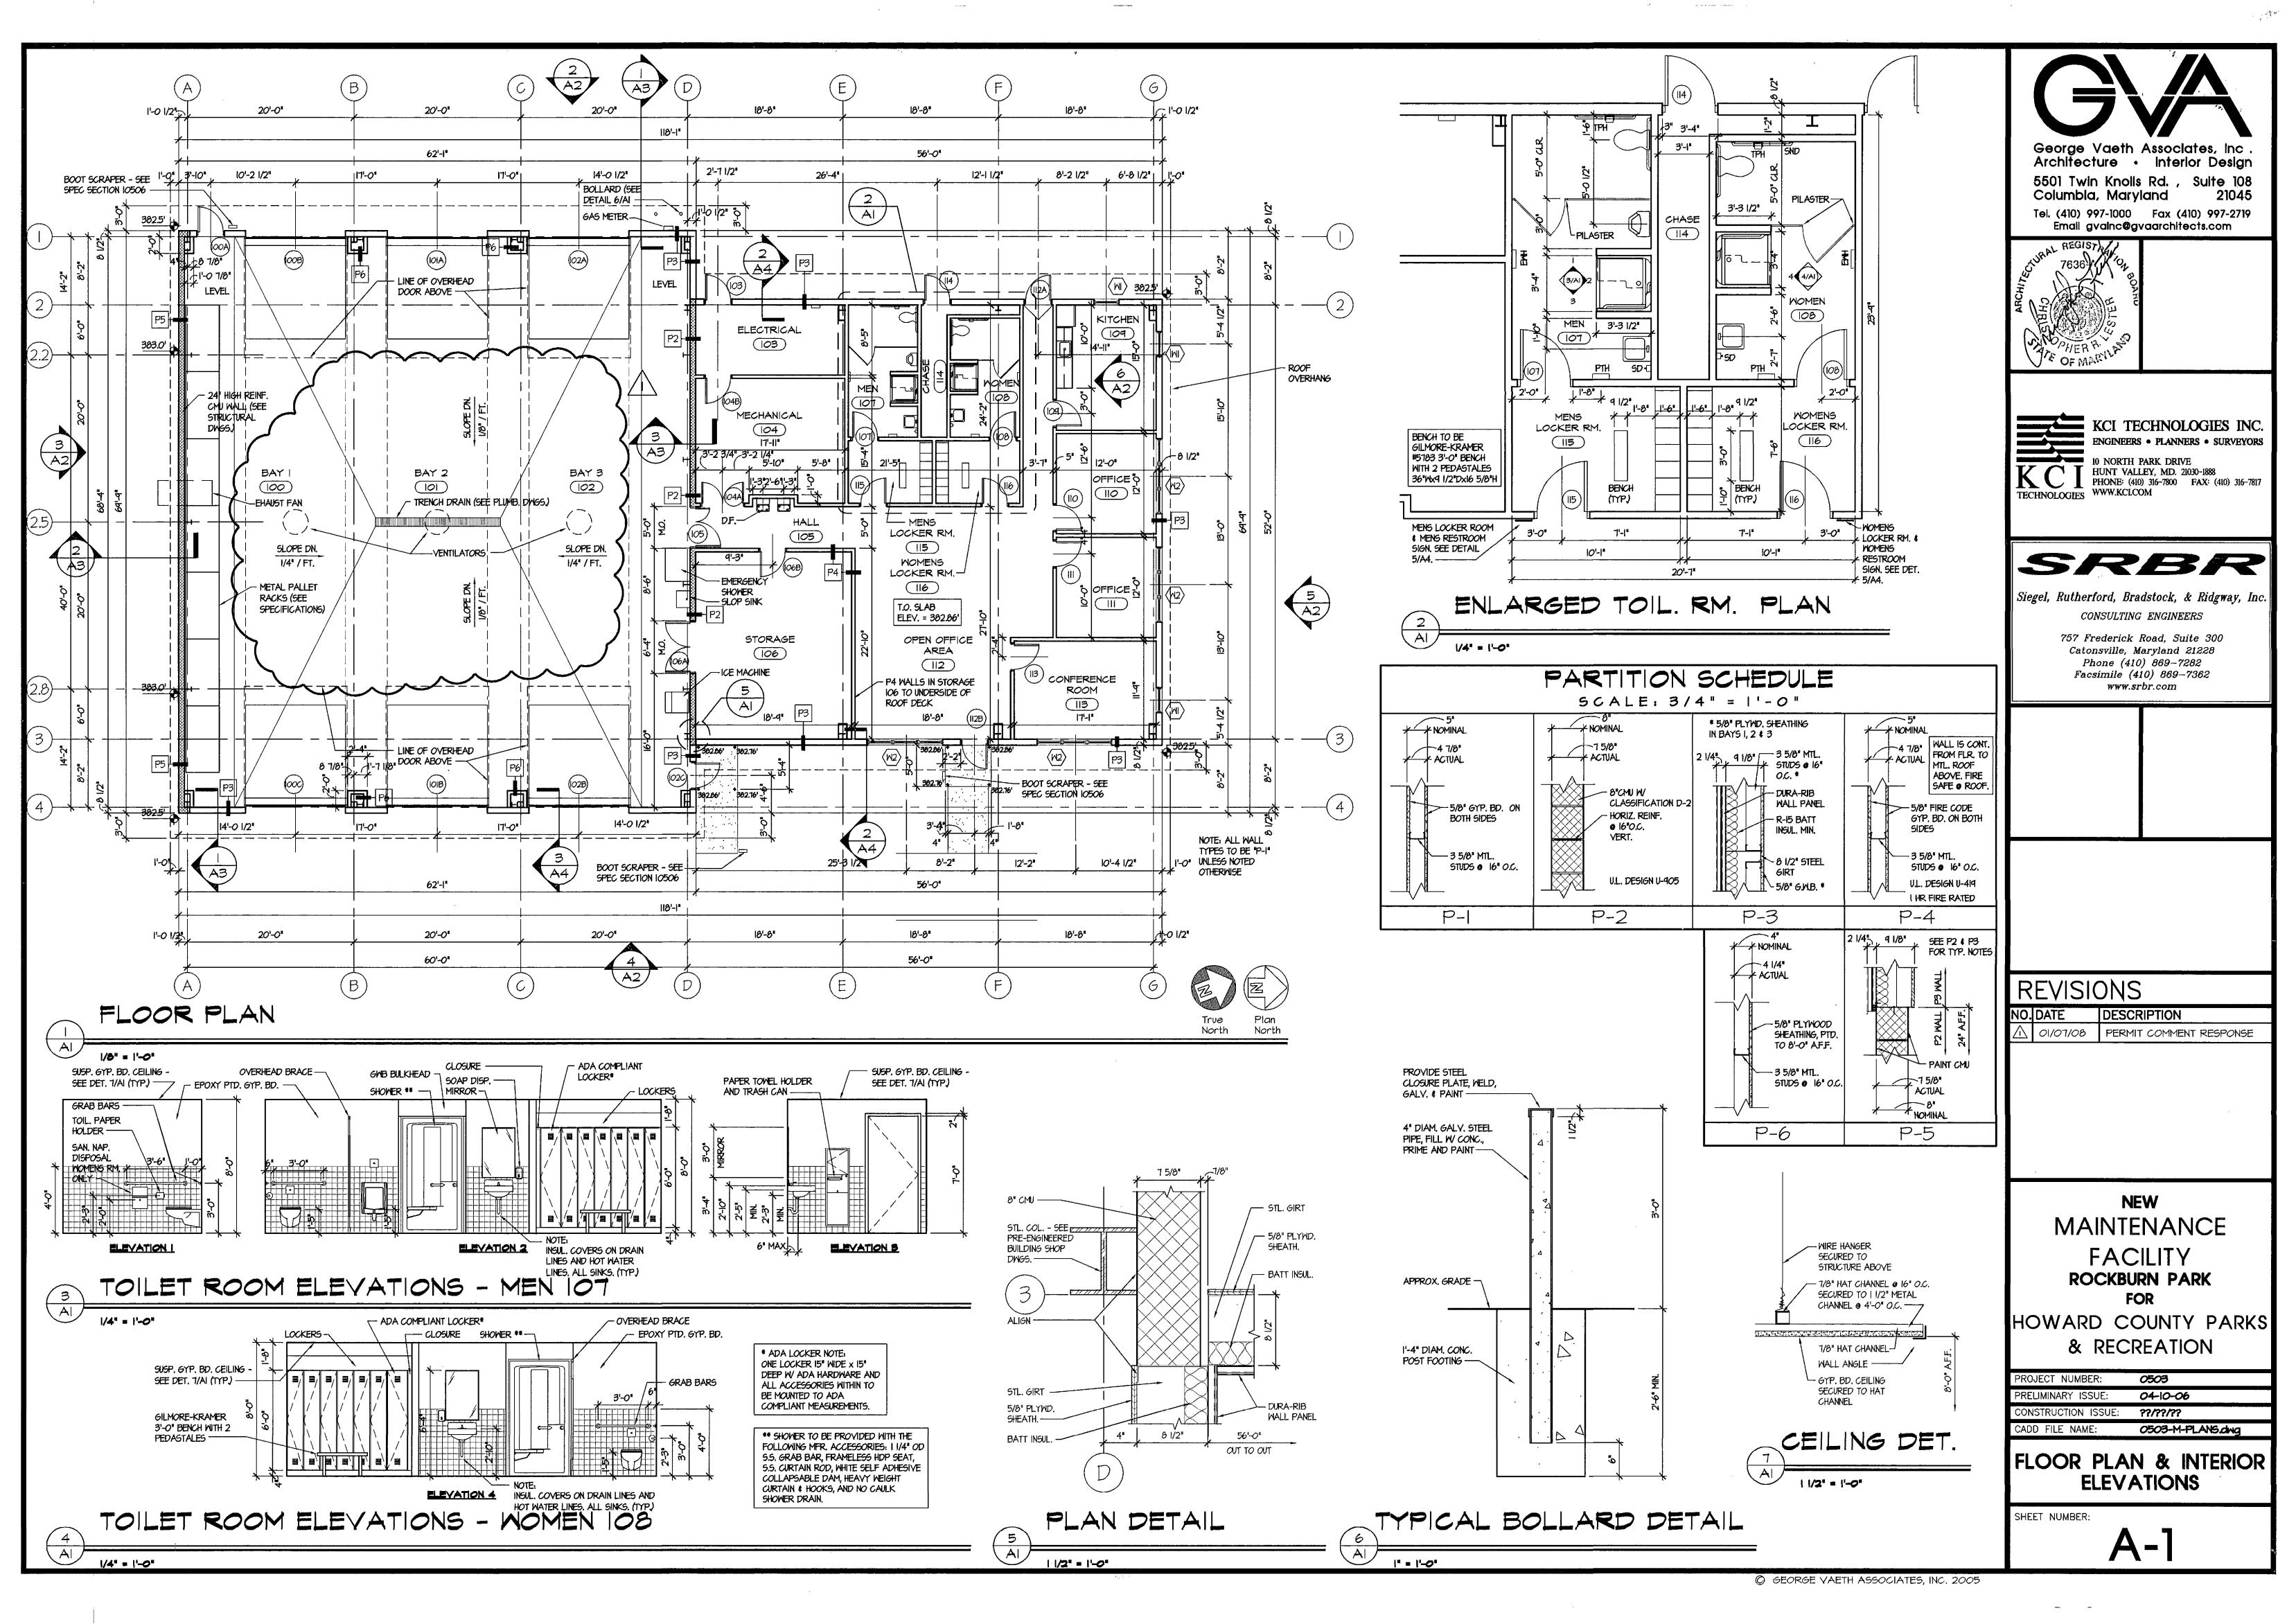


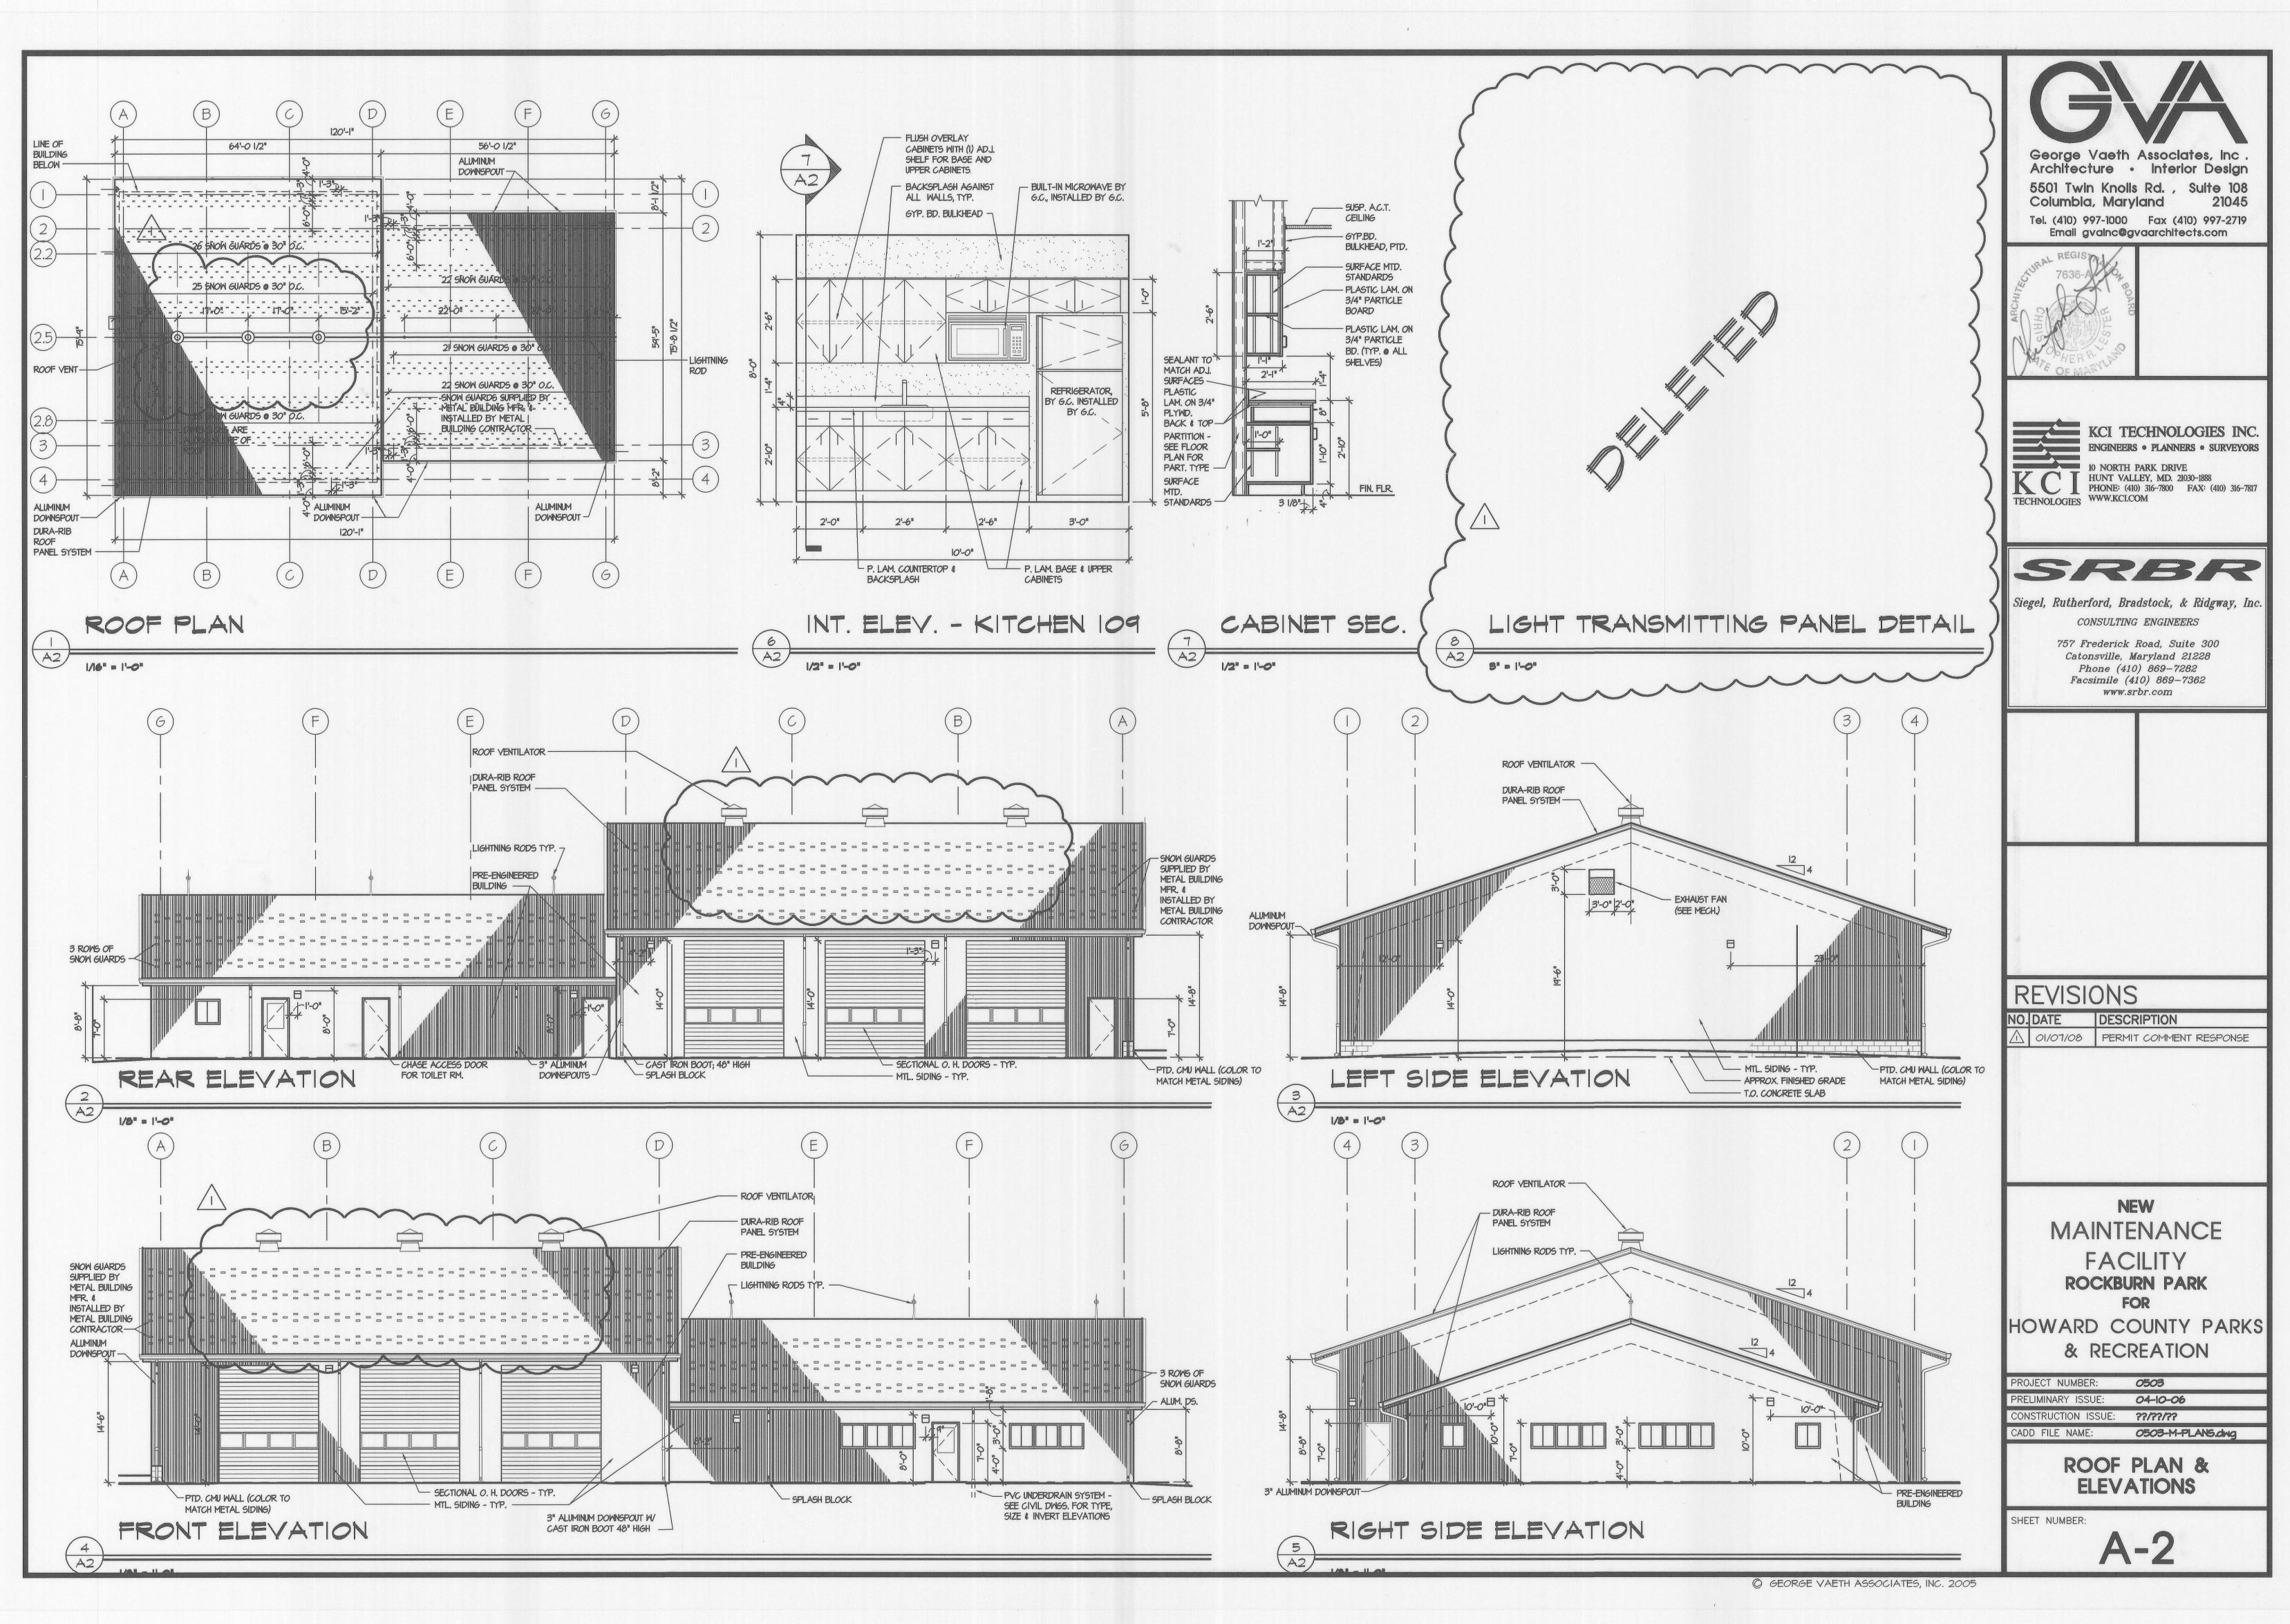

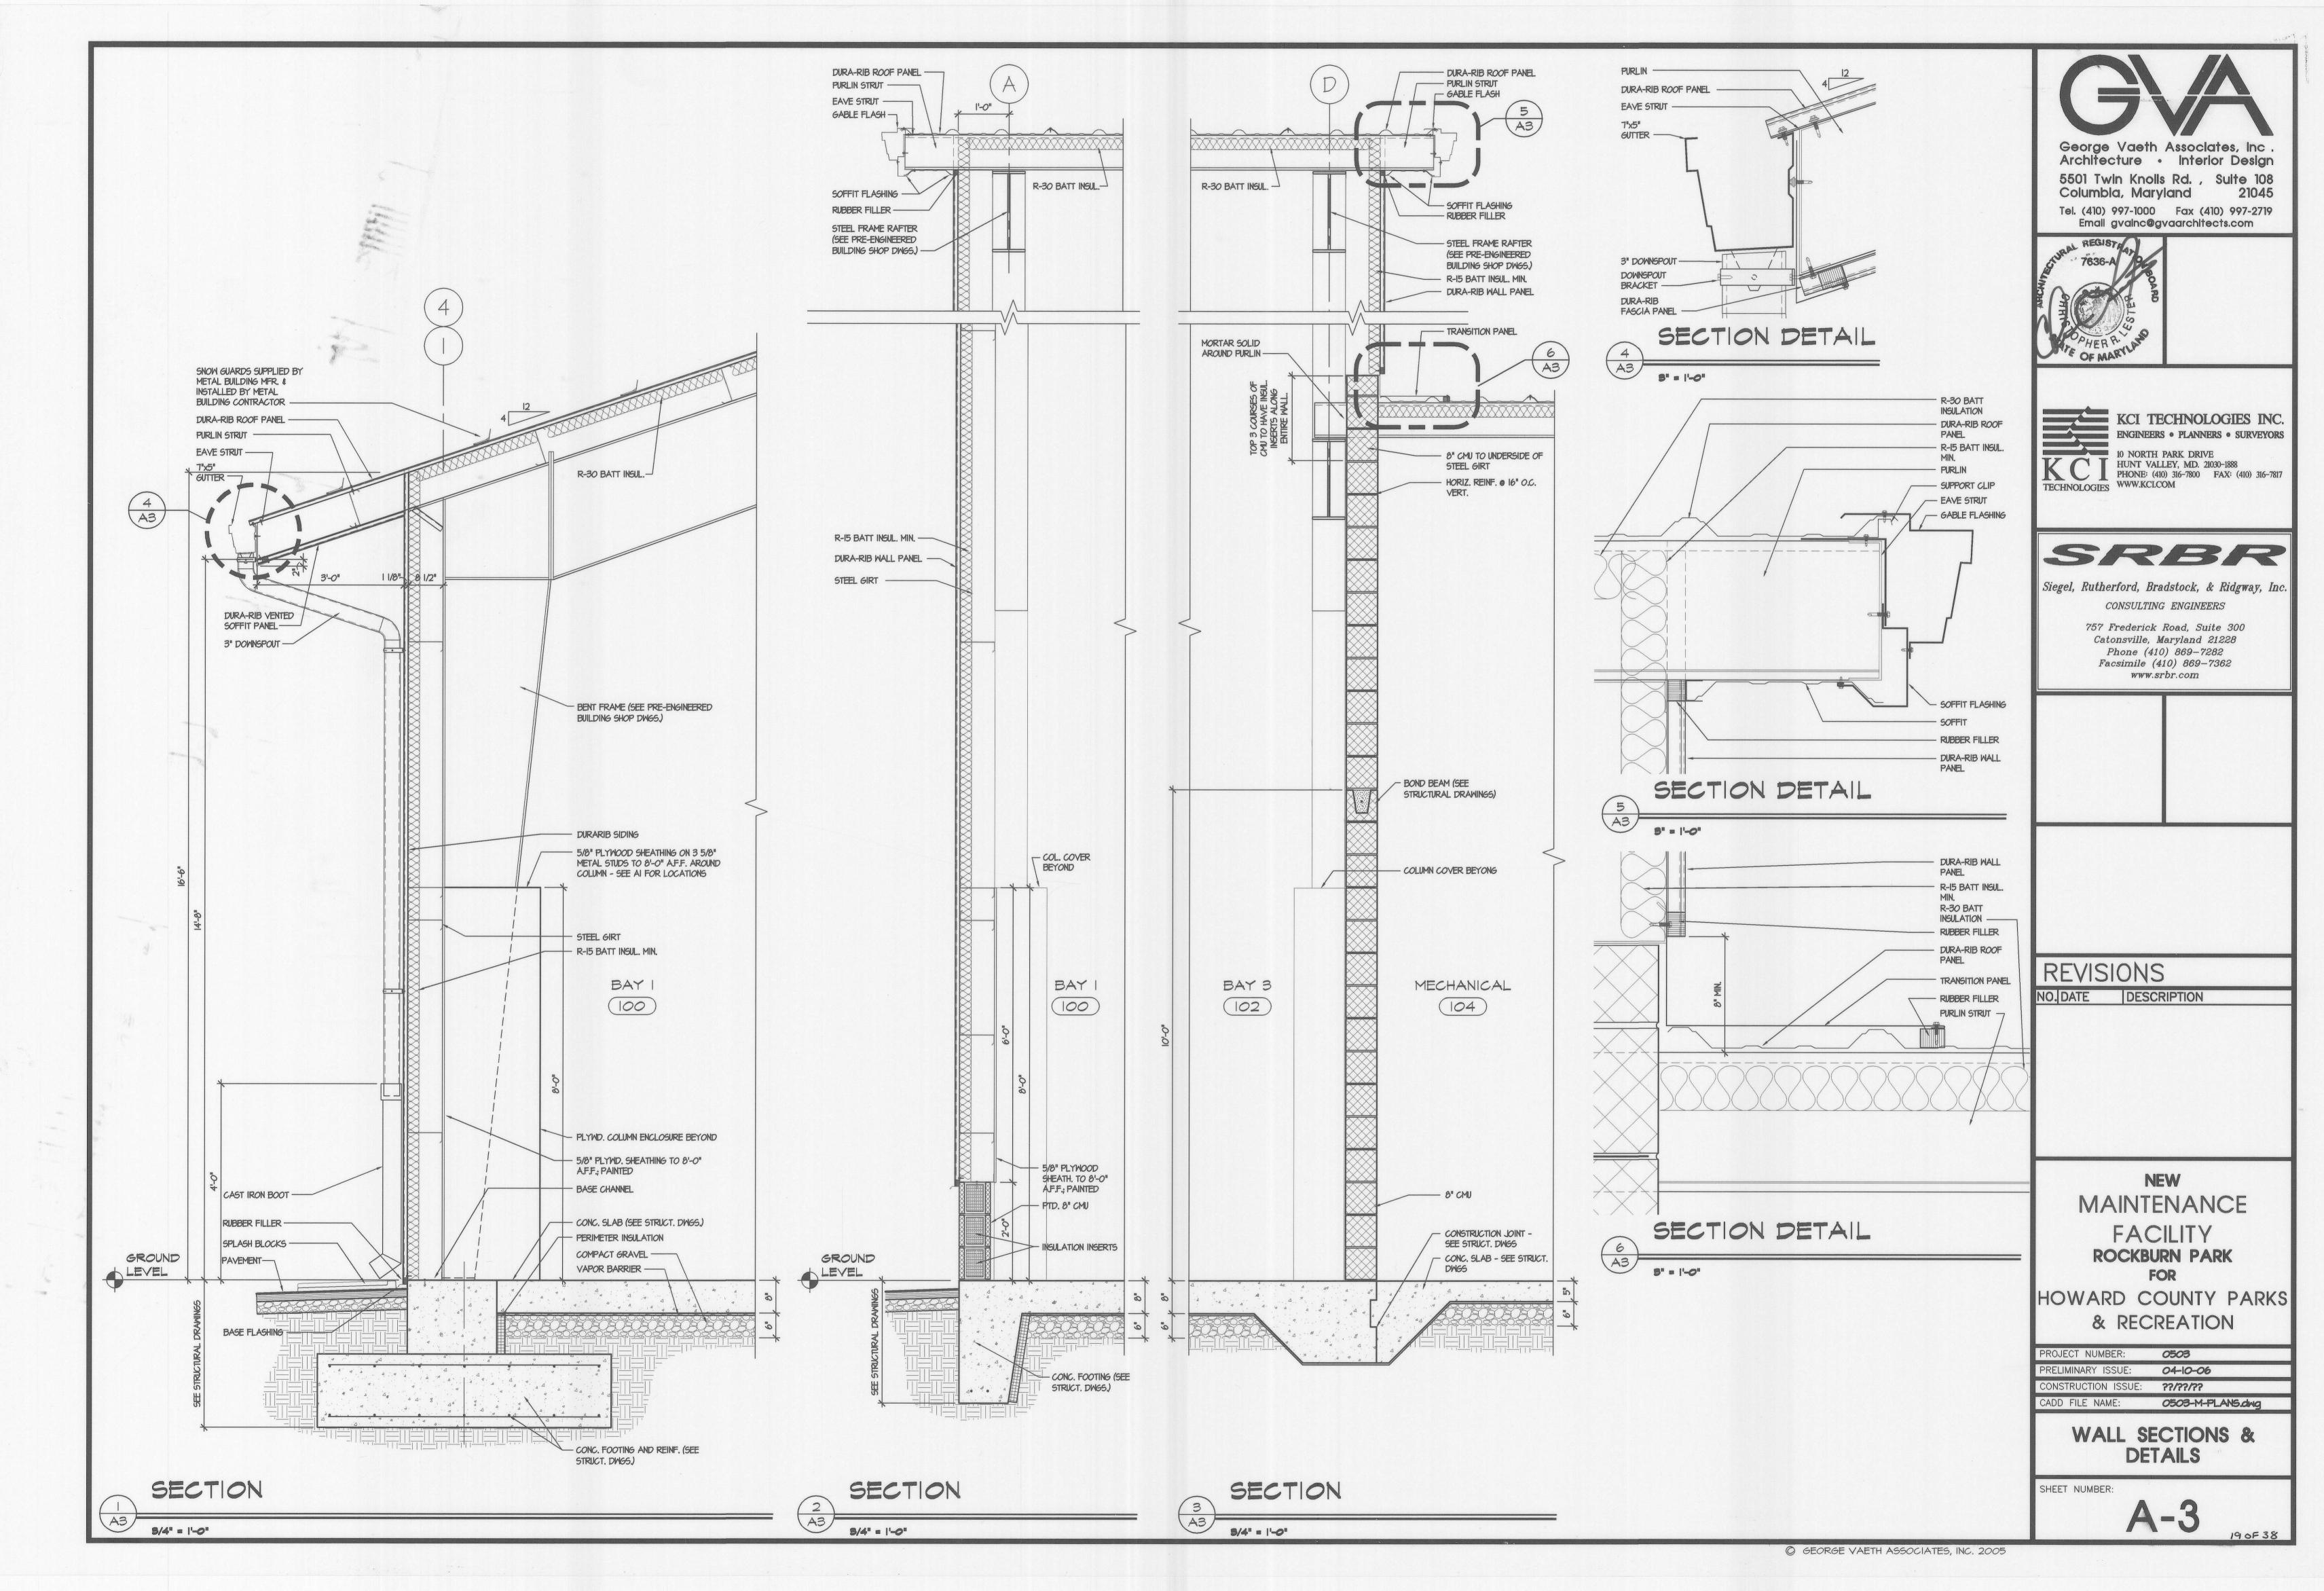

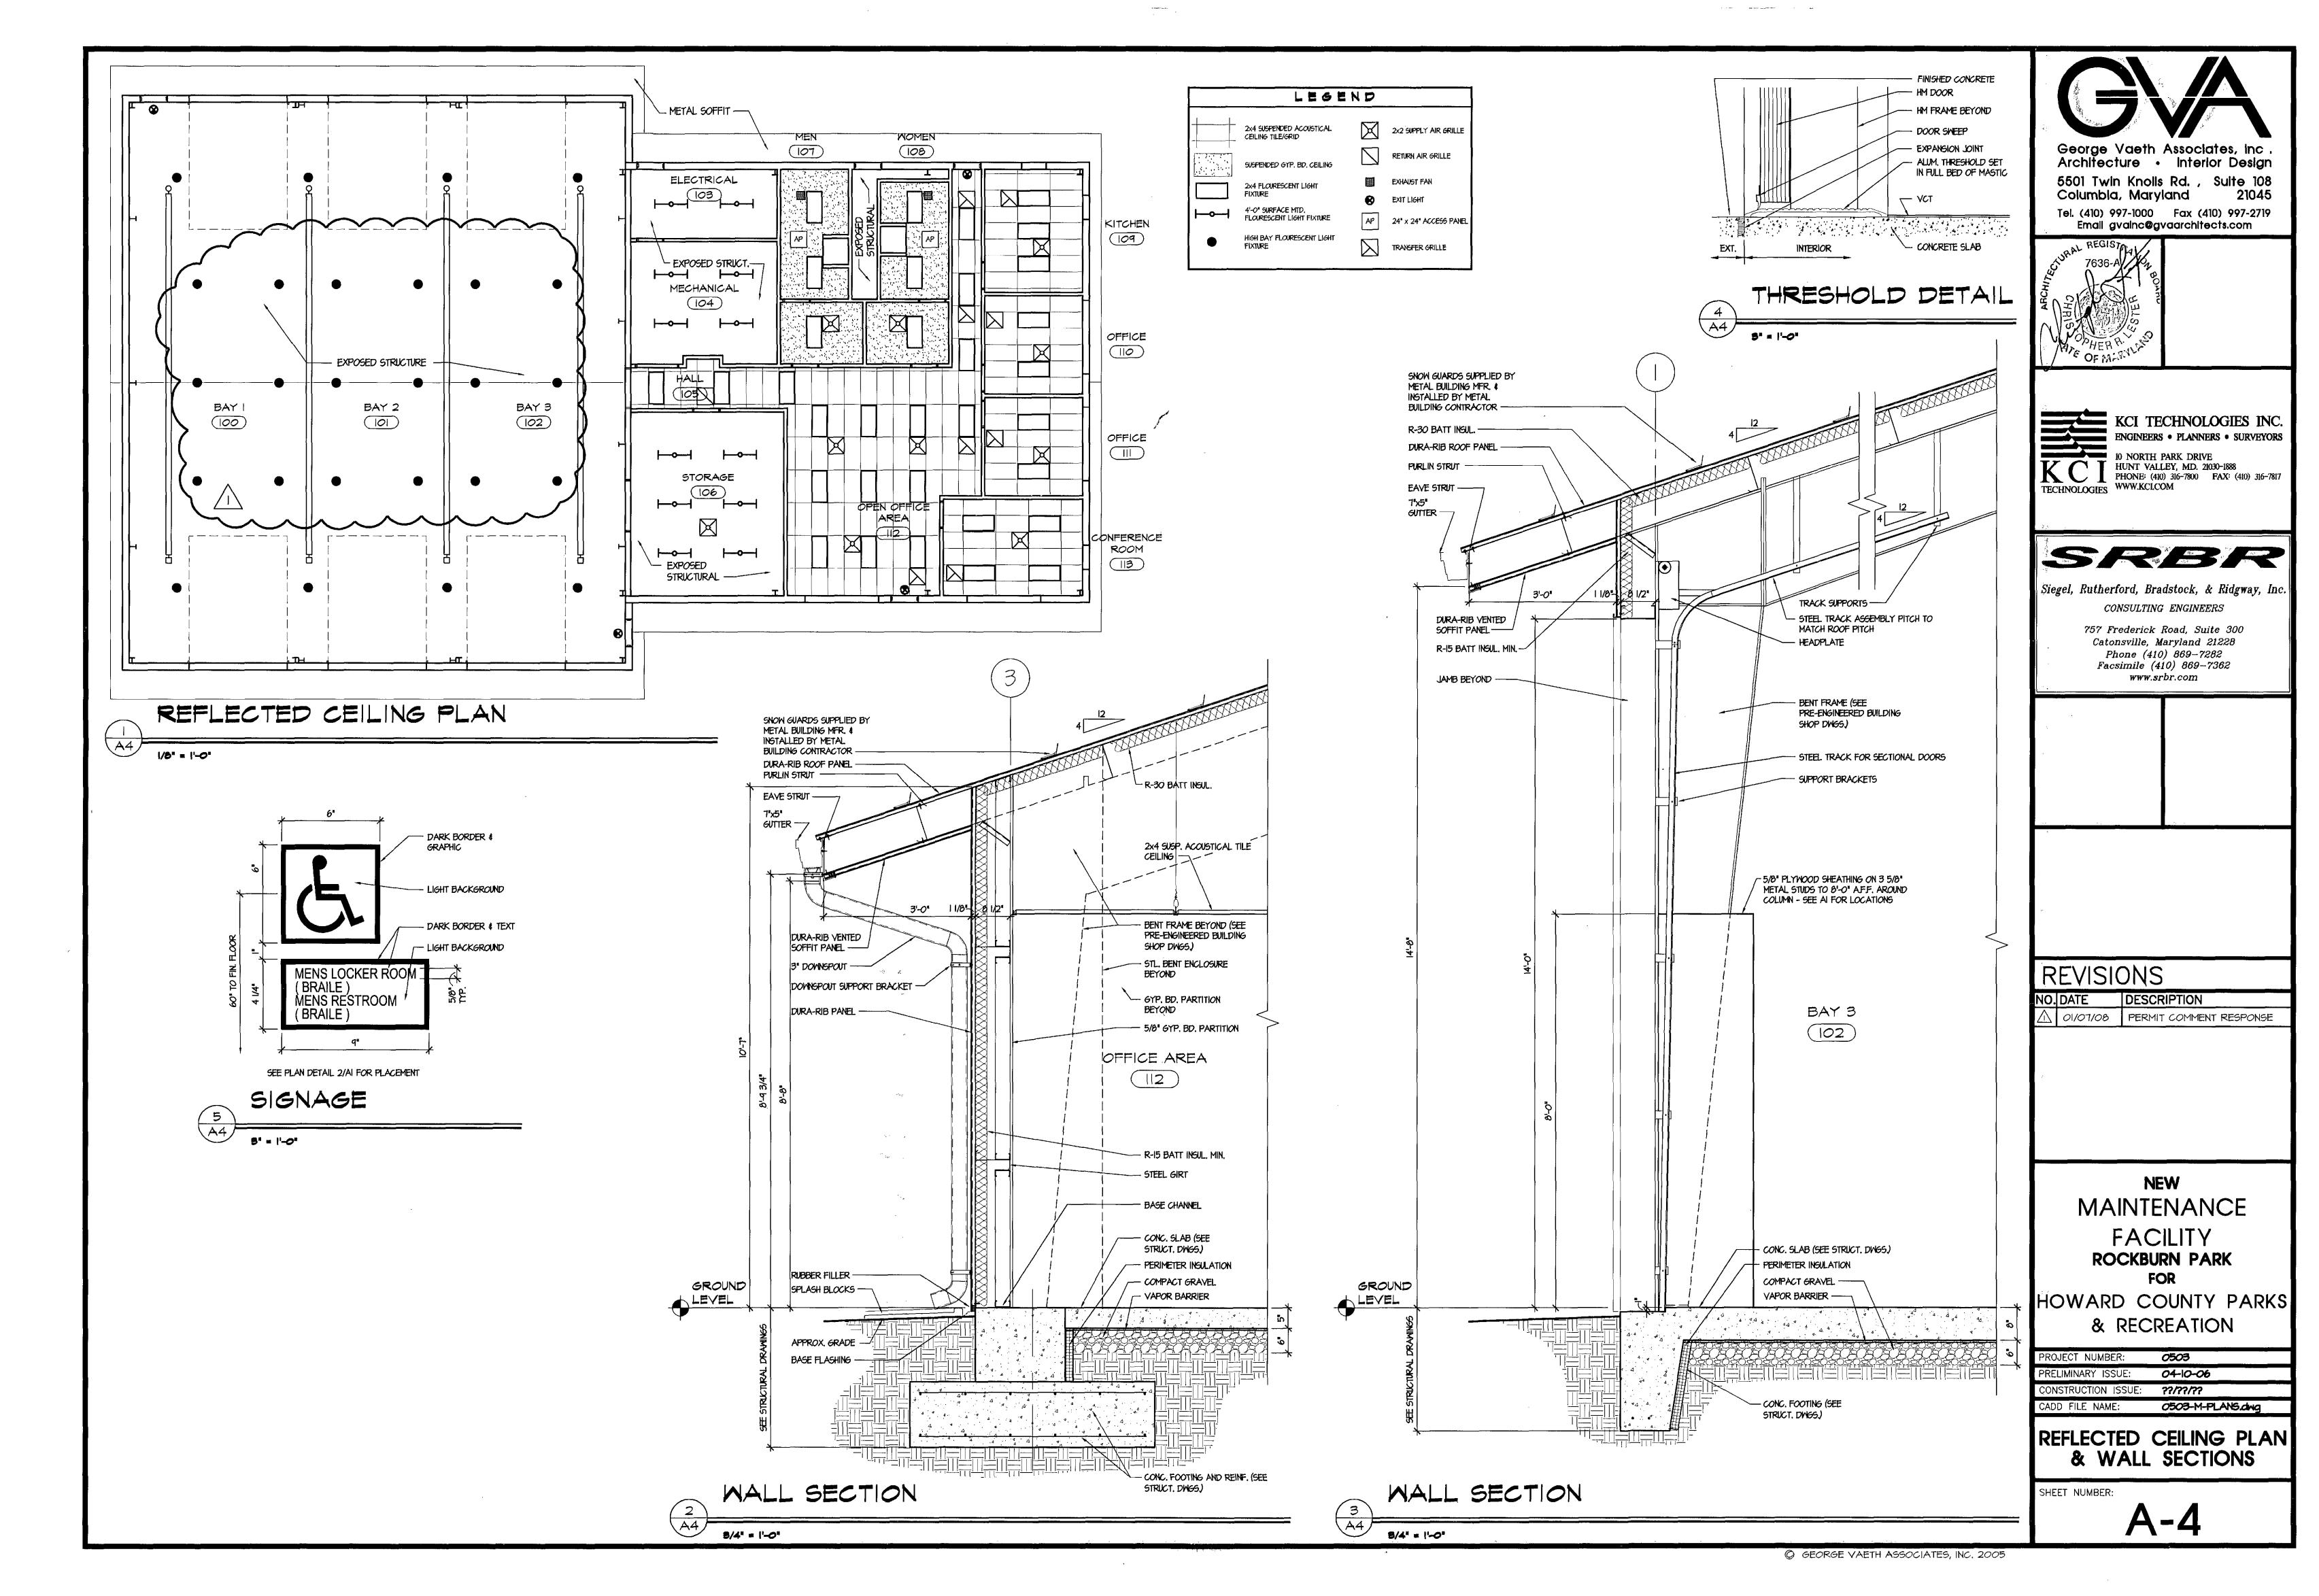

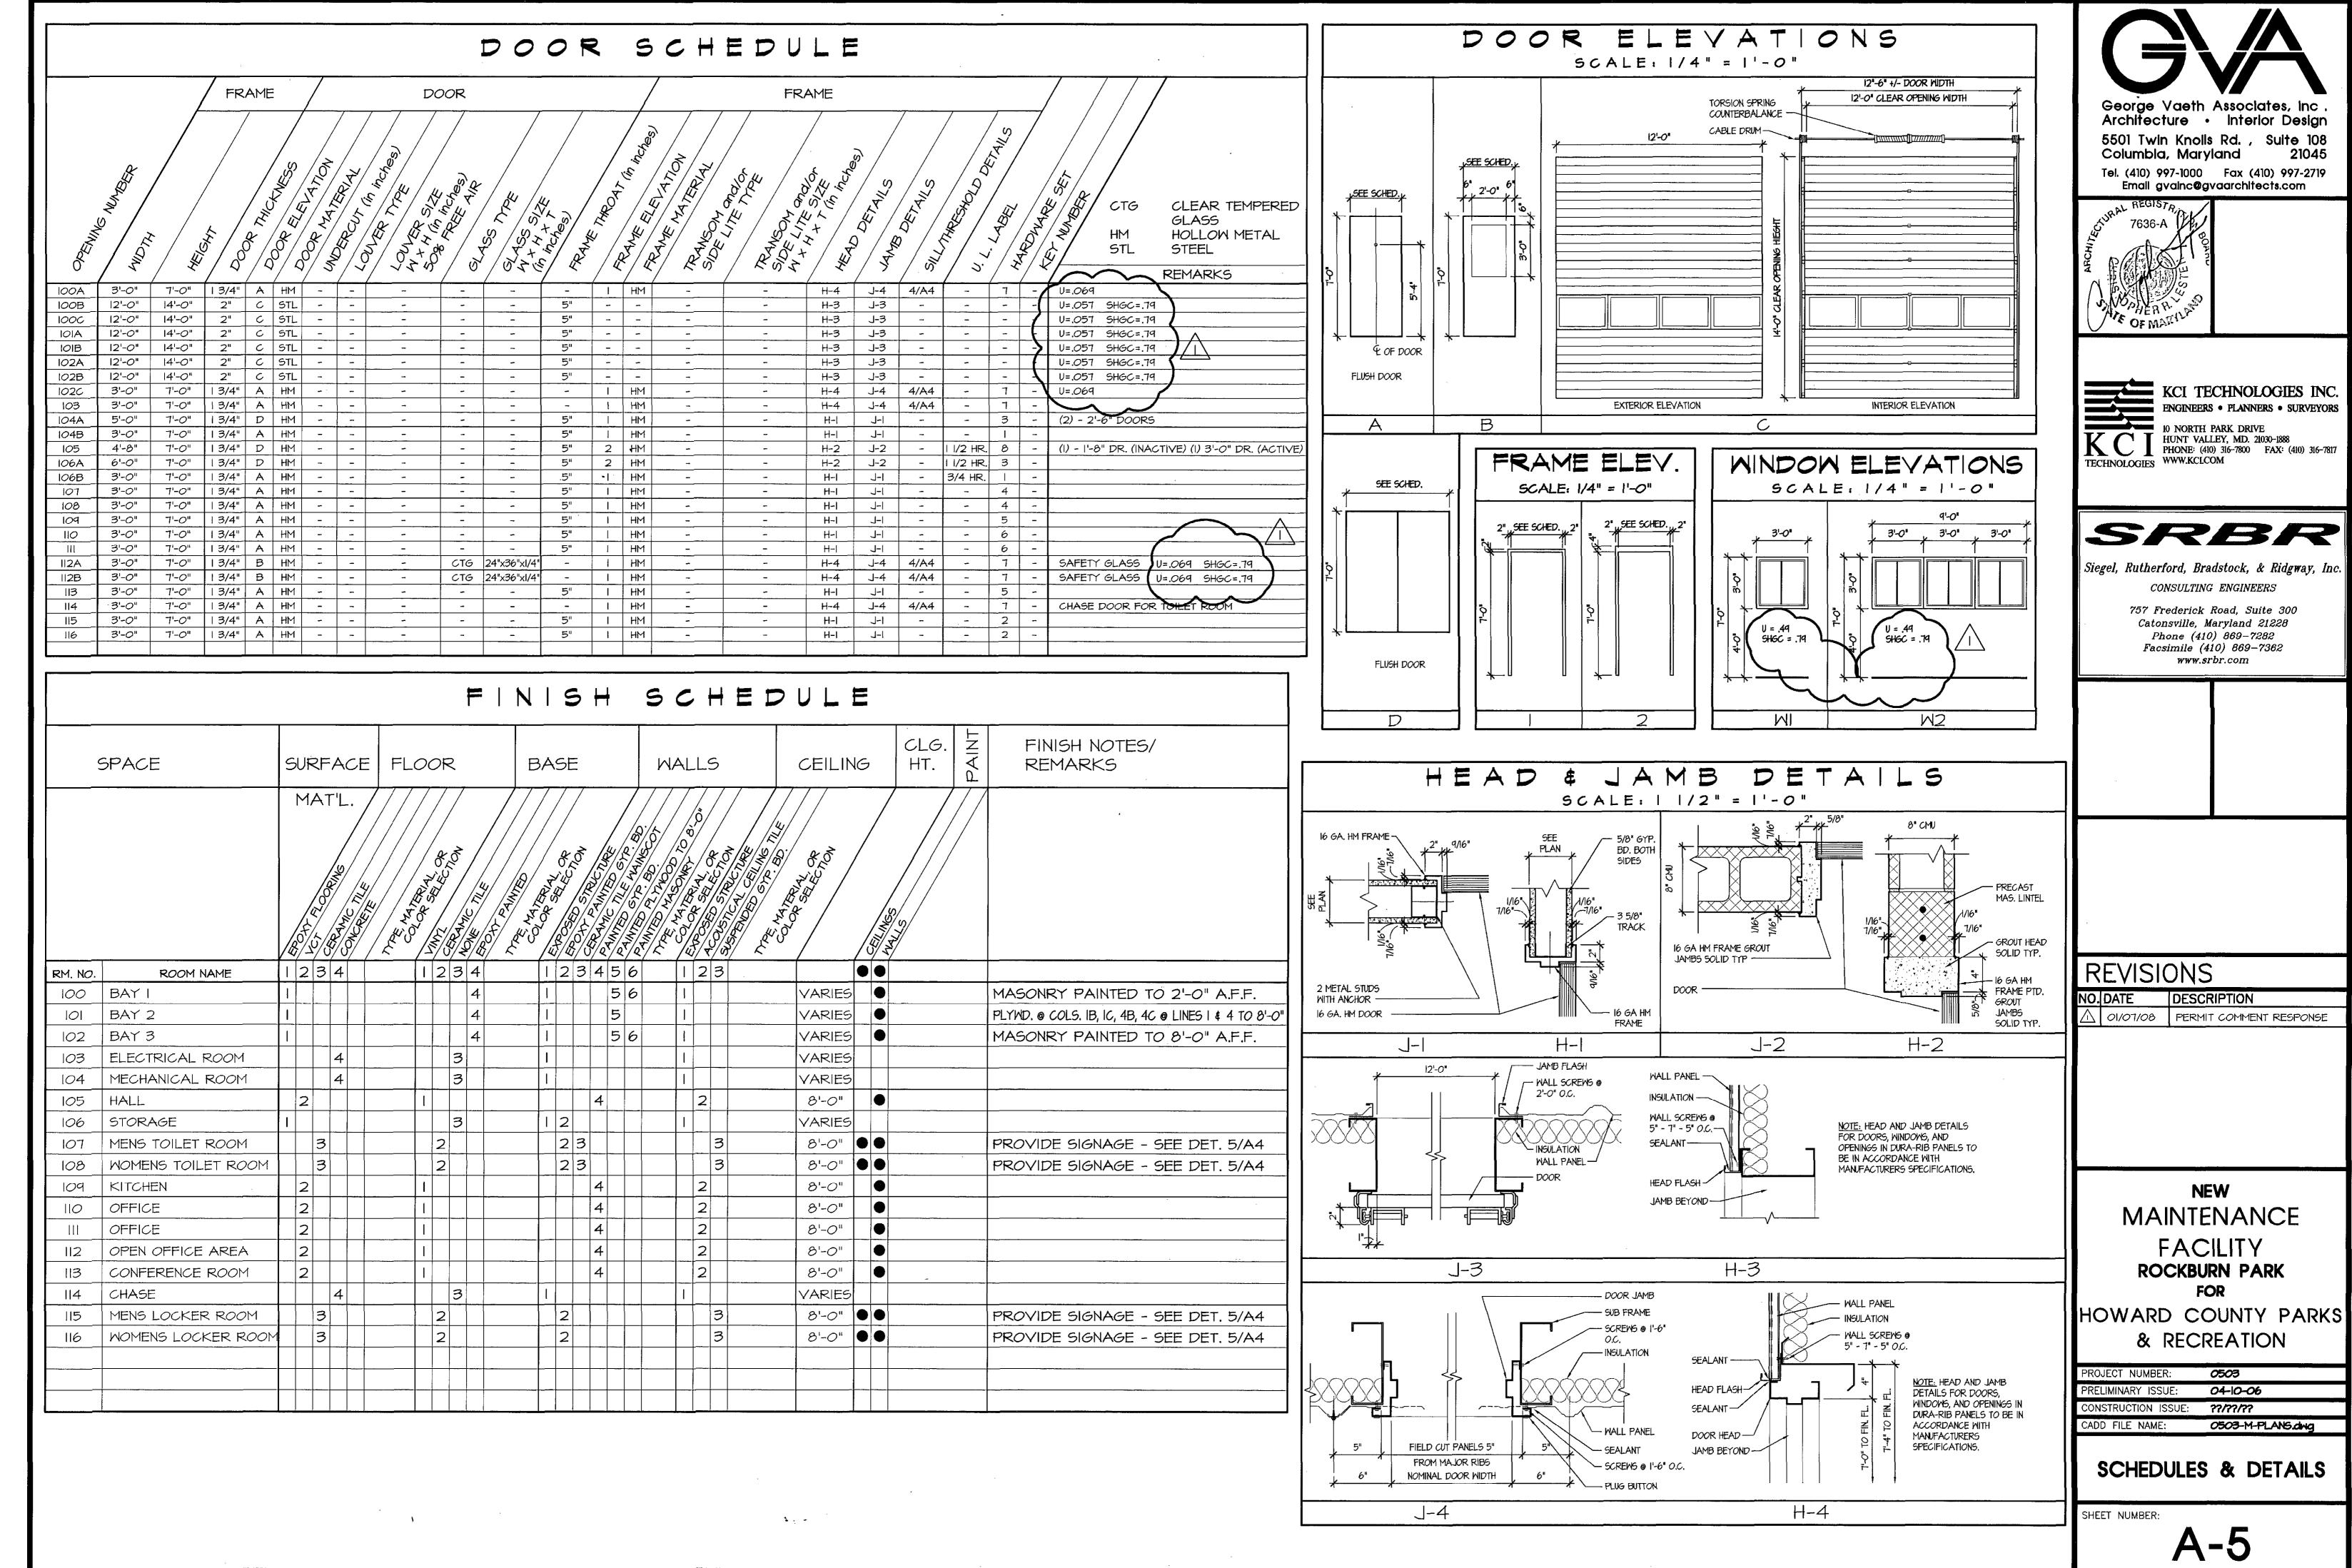

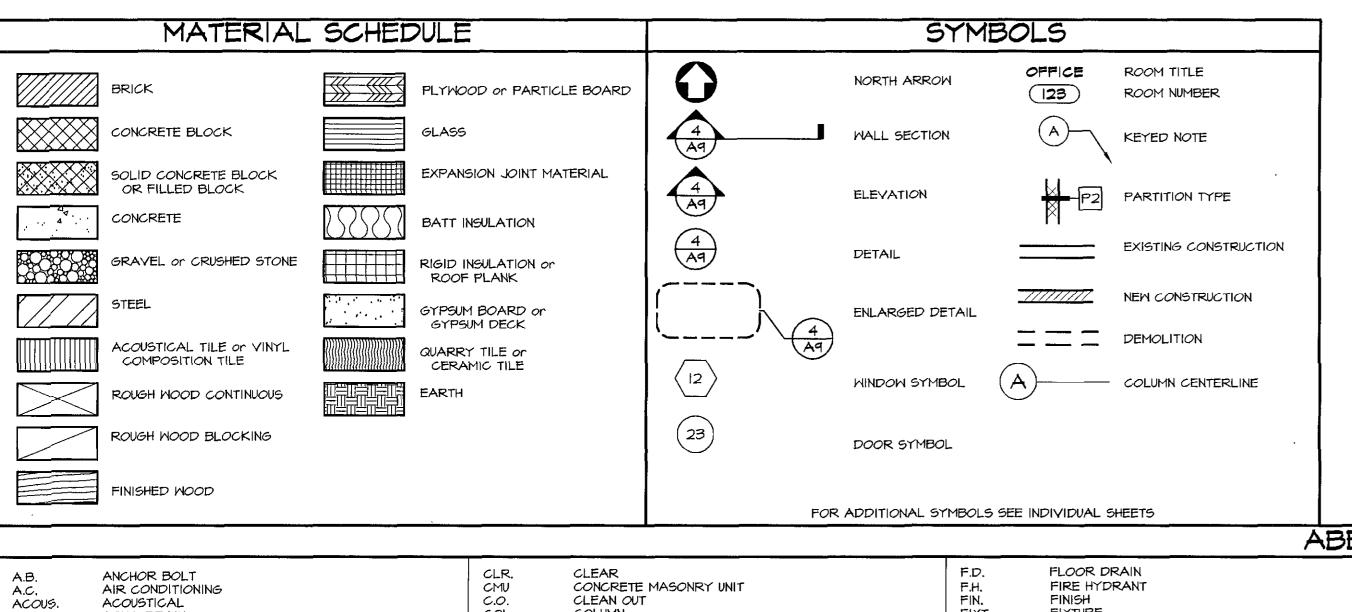

COL.

CONT.

CTSK.

C.W.G. DBL. DET. D.F.

D.S.

DWG(S)

E.I.F.S.

ELEC.

EQ.

EQUIP.

E.M.C. EXH.

EXIST.

DIA. OR \$

CONST. JT.

CONSTR.

A.D. A.F.F.

ALUM.

APPROX

ARCH.

ATT. A.T. B.C. BD. BLDG.

BLK, BLKG.

BM. BOT. BRG. BRK. B.S. BSMT. B.U. C.AB.

CARP.

CB. CEM.

ČLG. CLO.

AREA DRAIN

ALTERNATE

APPROXIMATELY

ACOUSTICAL TILE

BOTTOM OF CURB

ALUMINUM

ATTACHED

BOARD

BLOCK

BEAM

BRICK

BUILDING

BLOCKING

BOTTOM

BEARING

BOTH SIDES

BASEMENT

BUILT UP

COURSES

CABINET

CARPET

CEMENT

CEILING

CLOSET

CAST IRON

CENTERLINE

CHALKBOARD

CONTROL JOINT

ANGLE

ABOVE FINISHED FLOOR

ARCHITECTURAL or ARCHITECT

COLUMN

DOUBLE

DETAIL

DOWN

DIAMETER

DIMENSION

DOWNSPOUT

DRAWING(S)

ELEVATION

EQUIPMENT

EQUAL

EXHAUST

EXISTING

EXTERIOR

ELECTRIC(AL)

CONCRETE

CONSTRUCTION

CONTINUOUS

CERAMIC TILE

COUNTERSUNK

CONSTRUCTION JOINT

CLEAR WIRE GLASS

DRINKING FOUNTAIN

DAMP PROOFING

FOR EXAMPLE

EXPANSION JOINT

ELECTRICAL PANEL


ELEVATION or ELEVATOR

ELECTRIC WATER COOLER

EXPANSION or EXPOSED

CORRUGATED or CORRIDOR

EXTERIOR INSULATION & FINISH SYSTEM

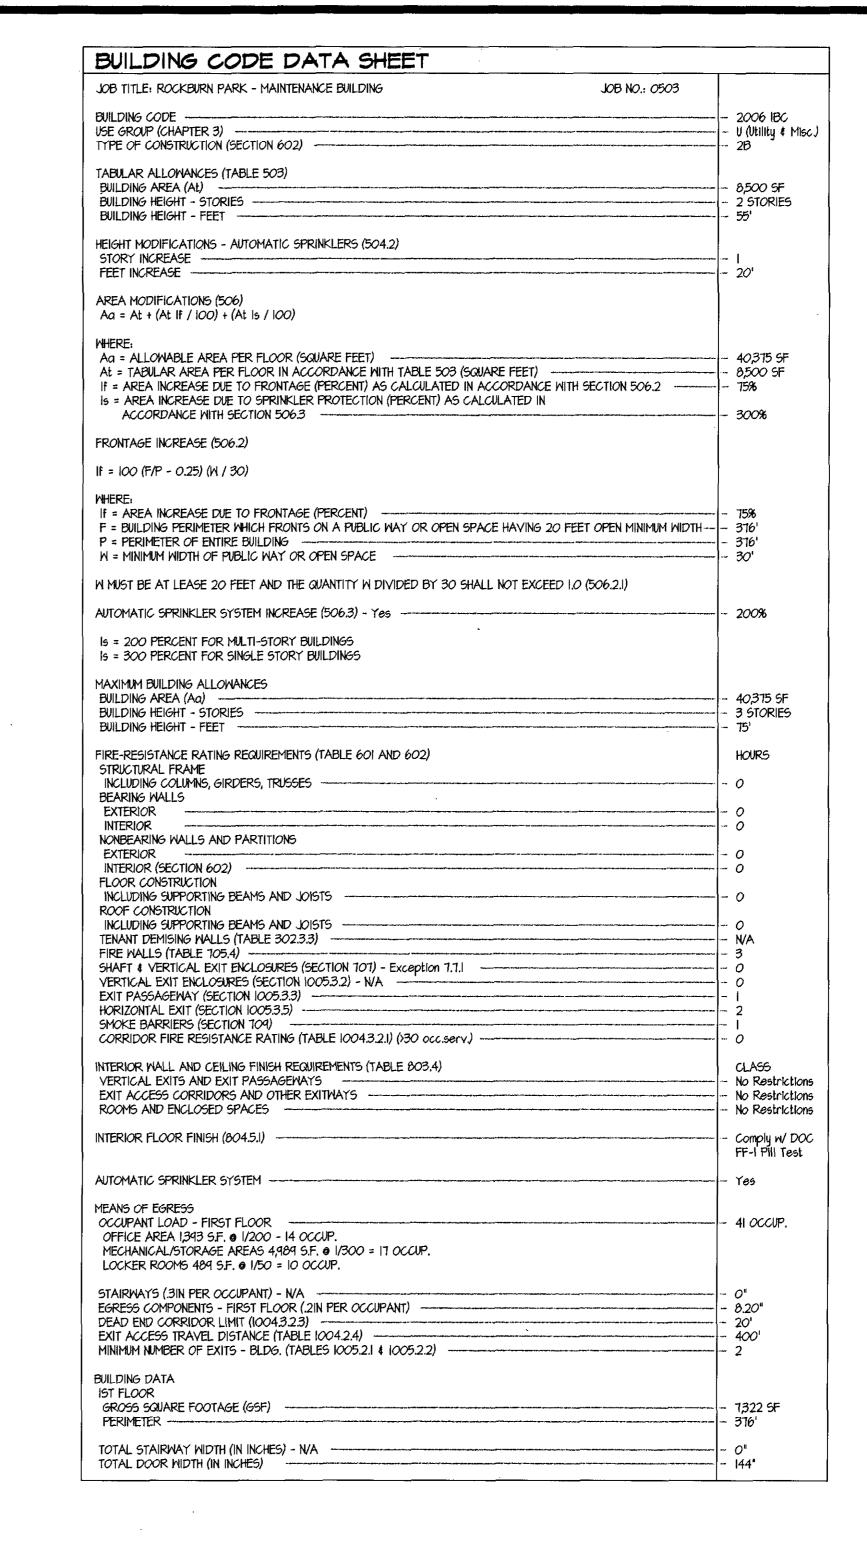

PLAS. PLYMD.

PNL. PR. PREFAB.

POL. P.T. P.T.D.

PTD. Q.T.

R.A. R.D. REINF. REQ'D. R.F.M.

R.L. RAIL. RM, RND. R.O. S.A.

SAN. S.G.F.T S.C. S.D. SCH. SEAL. SECT.

SIM S.M.

SPECS.

50. or th 5.5. 5/5 STD.

JANITOR CLOSET

LONG LEG HORIZONAL

LONG LEG VERTICAL

MIRROR or METER

MEDICINE CABINET

MANUFACTURE(R)

MOP HOOK STRIP

MISCELLANEOUS

MASONRY OPENING

METAL THRESHOLD

NOT IN CONTRACT

OUTSIDE DIAMETER

OPPOSITE HAND

NOT TO SCALE

ON CENTER

OVERHEAD

PARTITION

OFFICE

PLATE

LAMINATE

LOW POINT

MASONRY

MAXIMUM

MATERIAL

MECHANICAL

MEMBRANE

MEZZANINE

MANHOLE

MINIMUM

MOUNTING

METAL

LAM. L.L.H.

L.L.V. L.P. LT.

M. MAS. MAX.

MAT'L M.C. MECH.

MIN. MEZZ. MFG(R)

MH.
M.H.S.
MIN.
MISC.
M.O.
MOD.
M.T.
MTG.
N.I.C.
N.T.S.
O.D.
OFF.
OH.

OPPHD PART.

MEMB, MET. OR MTL.

PLASTIC or PLASTER

PAPER TOWEL DISPENSER

REINFORCE(MENT) or REINFORCING

STRUCTURAL GLAZED FACING TILE

RECESSED FLOOR MATERIAL

PLYMOOD

PREFABRICATE

POLISHED
PARTITION TYPE

RISER or RADIUS

PANEL

PAINTED

QUARRY TILE

RETURN AIR

ROOF DRAIN

RAIN LEADER

ROUGH OPENING

SUPPLY AIR

SOLID CORE

SOAP DISPENSER

SANITARY

SCHEDULE

SEALANT

SECTION

SIMILAR

SQUARE

SHEET METAL

SPECIFICATIONS

SLATE SADDLE

STAINLESS STEEL STANDARD

REQUIRED

RAILING


ROOM

ROUND

PAIR



Architecture • Interior Design 5501 Twin Knolls Rd., Suite 108 Columbia, Maryland Tel. (410) 997-1000 Fax (410) 997-2719

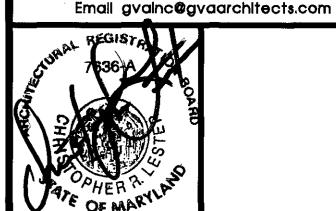

TECHNOLOGIES WWW.KCI.COM

KCI TECHNOLOGIES INC. ENGINEERS • PLANNERS • SURVEYORS 10 NORTH PARK DRIVE HUNT VALLEY, MD. 21030-1888 PHONE: (410) 316-7800 FAX: (410) 316-7817



CONSULTING ENGINEERS 757 Frederick Road, Suite 300 Catonsville, Maryland 21228

Siegel, Rutherford, Bradstock, & Ridgway, Inc.

Phone (410) 869-7282 Facsimile (410) 869-7362 www.srbr.com

REVISIONS

NO.DATE DESCRIPTION

NEW MAINTENANCE

FACILITY ROCKBURN PARK FOR

HOWARD COUNTY PARKS & RECREATION

PROJECT NUMBER:	0503
PRELIMINARY ISSUE:	04-10-06
CONSTRUCTION ISSUE:	??/??/??
CADD FILE NAME:	0503-M-DATA.dng

DATA SHEET

SHEET NUMBER:

T.O.S. T.O.S.L. TOP OF SLAB T.W, TYP. TOP OF WALL TYPICAL UNIT VENTILATOR U.V. U.N.O. UNLESS NOTED OTHERWISE YERT. VERTICAL V.C.T. V.I.F. VINYL COMPOSITION TILE VERIFY IN FIELD MIDTH W. WO W.C. MITHOUT WATER CLOSET or WALL COVERING MD. MIND, MINDOM WALL MOUNTED ADJUSTABLE W.M.A.S. SHELVES M.P. WEATHERPROOF or WATERPROOF WATERPROOFED MEMBRANE MP. MEM. WELDED WIRE MESH M.M.M. YD. @ GEORGE VAETH ASSOCIATES, INC. 2005

STORAGE

SYNTHETIC

TACK BOARD

TELEPHONE

THRESHOLD

TOP OF STEEL

TOILET

TREAD

TOP OF

STRUCTURE or STRUCTURAL

SUSPENDED or SUSPENSION

TEMPERED, TEMPORARY, or

TEMPERATURE TOILET PAPER HOLDER

TONGUE & GROOVE

STRUCT.

SUSP. SYN.

TB. TEL.

TEMP.

T.P.H.

T\$6

THK. THRES.

TOIL. TR. or T.

					FOR	ADDITIONAL SYM		OVAL SHEETS OOR DRAIN	AE	BREV	IATION	15
	FINISHED WOOD											
	ROUGH WOOD BLOCKING			23		DOOR SYMBOL						
	ROUGH WOOD CONTINUOUS		EARTH	(12)		MINDOM SYMBO	A —	COLUMN CENTERLINE				
	ACOUSTICAL TILE OF VINYL COMPOSITION TILE		QUARRY TILE or CERAMIC TILE		(4) (A9)			DEMOLITION				
	STEEL		GYPSUM BOARD or GYPSUM DECK			ENLARGED DET		NEW CONSTRUCTION				
	GRAVEL OR CRUSHED STONE		RIGID INSULATION or ROOF PLANK	(4) (Aq)		DETAIL		EXISTING CONSTRUCTI	ION			
44	CONCRETE	<u> </u>	BATT INSULATION	Aq			M					
	SOLID CONCRETE BLOCK OR FILLED BLOCK		EXPANSION JOINT MATERIAL	4		ELEVATION	<u>M</u>	-P2 PARTITION TYPE				
	CONCRETE BLOCK		GLASS	4 A9		WALL SECTION	A	KEYED NOTE				
	BRICK	$\longrightarrow \longrightarrow$	PLYWOOD or PARTICLE BOA	RD U			(123)) ROOM NUMBER				

FIXT.

FLUOR.

FTG.

F.E. GA. GALV. G.B. G.C.

GL. GR. G.M.B.

H. OR HT. H.B. H.C.

HD.

HDWE.

HT. HM. HORIZ.

HR. HTR. H.P. I.D.

INCAND.

INSUL. INTR. INV.

FIXTURE

FLOOR

FOOTING

GAUGE

GLASS

GRADE

GYPSUM

HOSE BIB

HARDWARE

HOLLOW CORE

HOLLOW METAL

INSIDE DIAMETER

INCANDESCENT

INTERIOR

INVERT

INTERIOR or INTERMEDIATE

HORIZONTAL

HEATER HIGH POINT

HEIGHT

HEIGHT

HOUR

FLUORESCENT

FEET or FOOT


GALYANIZED


GRAB BAR

FIRE EXTINGUISHER

GENERAL CONTRACTOR

GYPSUM WALL BOARD

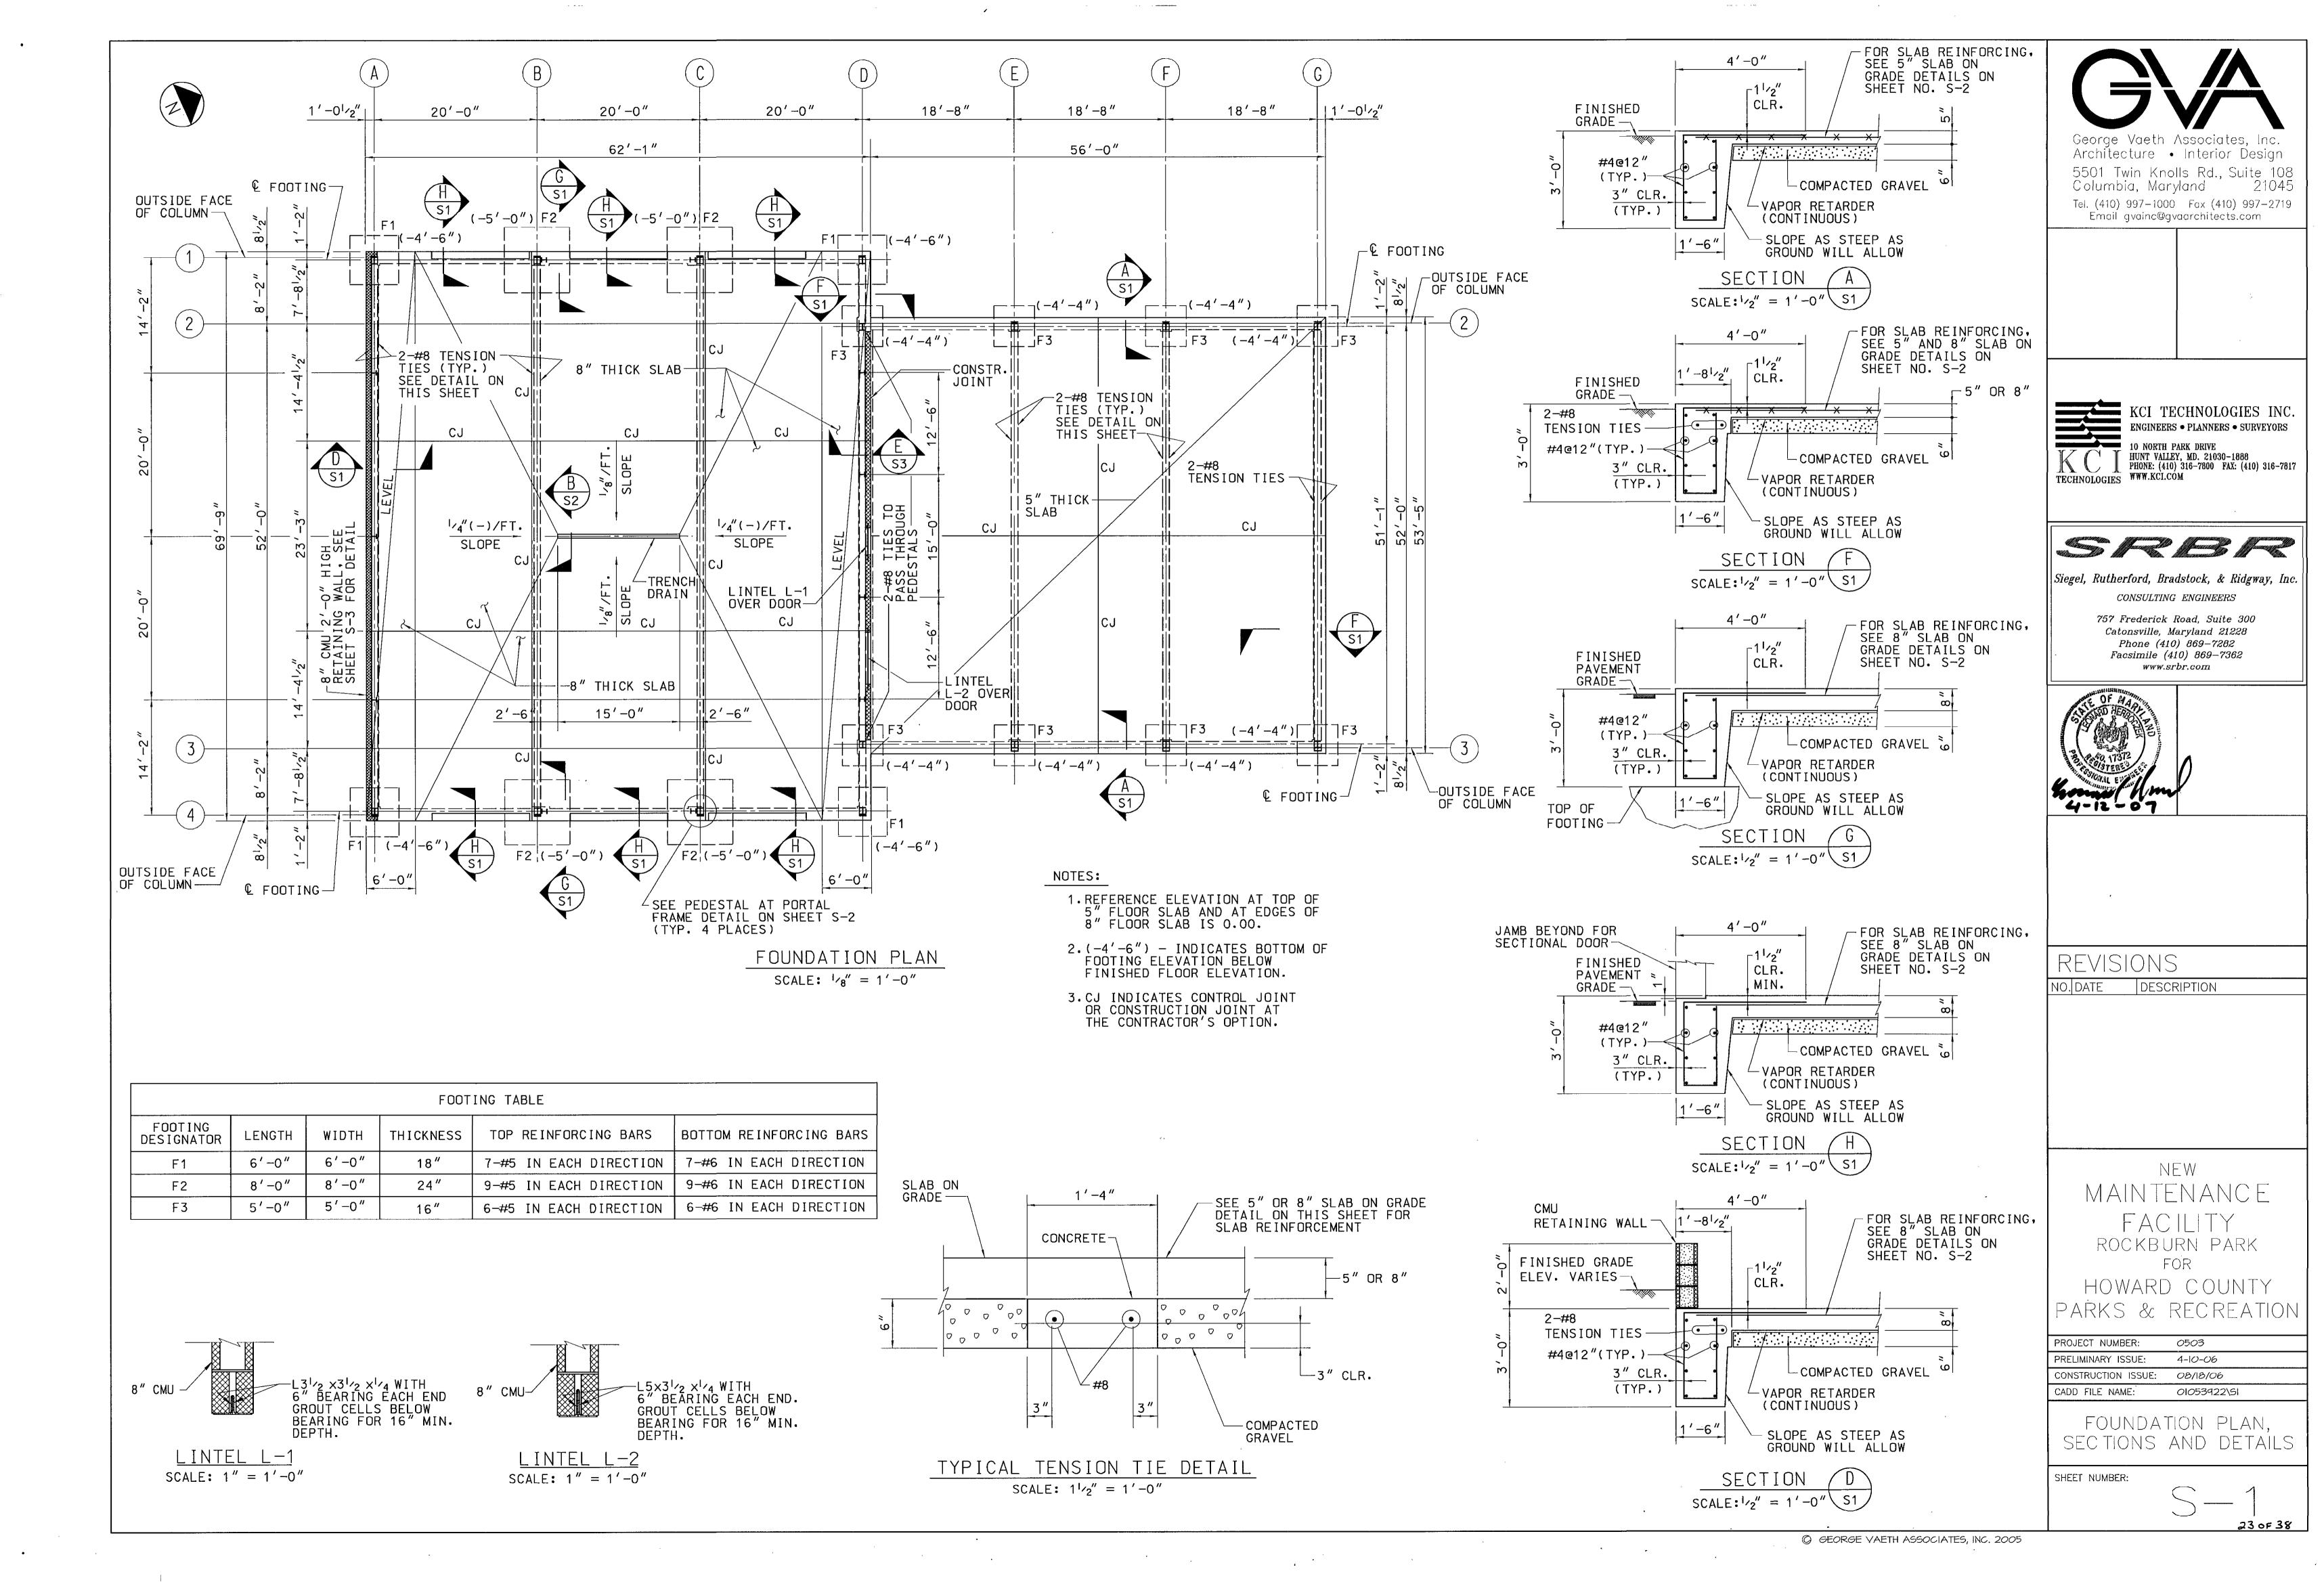

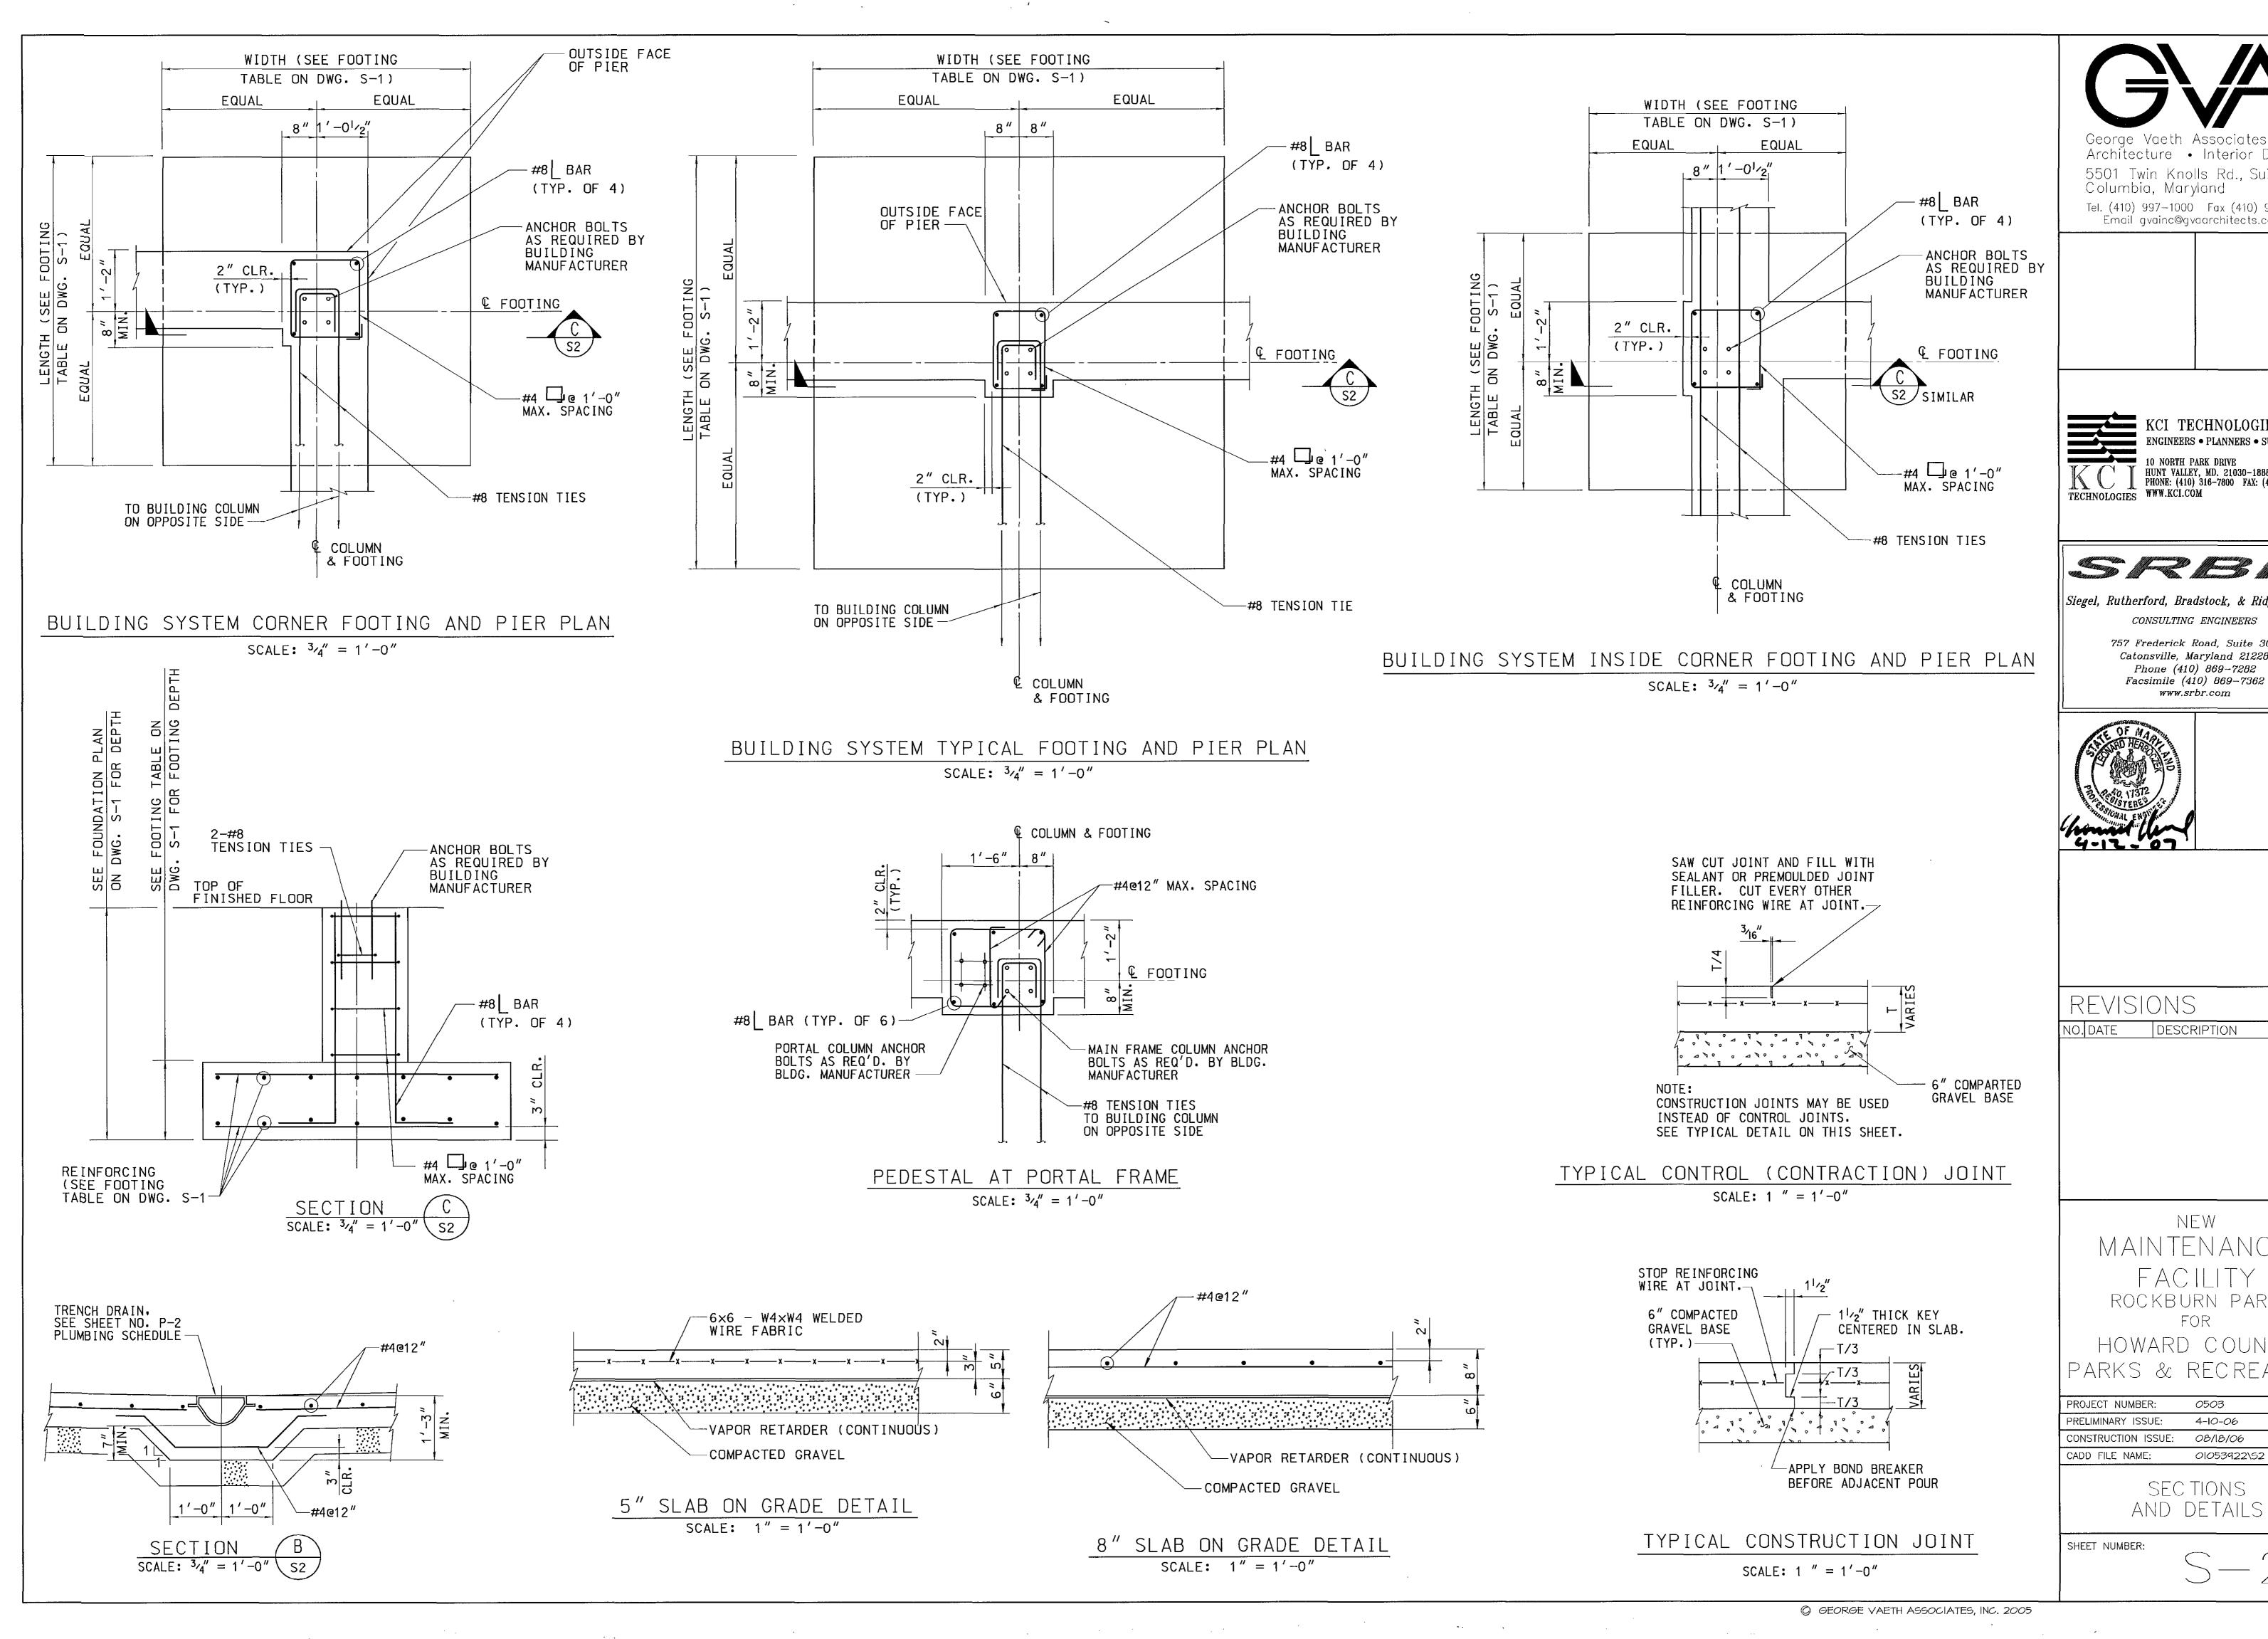

George Vaeth Associates, Inc. Architecture • Interior Design

5501 Twin Knolls Rd., Suite 108 Columbia, Maryland 21045

Tel. (410) 997—1000 Fax (410) 997—2719 Email gvainc@gvaarchitects.com

KCI TECHNOLOGIES INC. ENGINEERS • PLANNERS • SURVEYORS TECHNOLOGIES

HUNT VALLEY, MD. 21030-1888
PHONE: (410) 316-7800 FAX: (410) 316-7817

WWW.KCI.COM

Mariantino propiesamento formando propiesamento de la company de la comp

| Siegel, Rutherford, Bradstock, & Ridgway, Inc. CONSULTING ENGINEERS


757 Frederick Road, Suite 300 Catonsville, Maryland 21228 Phone (410) 869-7282 Facsimile (410) 869-7362


MAINTENANCE

ROCKBURN PARK

HOWARD COUNTY PARKS & RECREATION

01053922\52

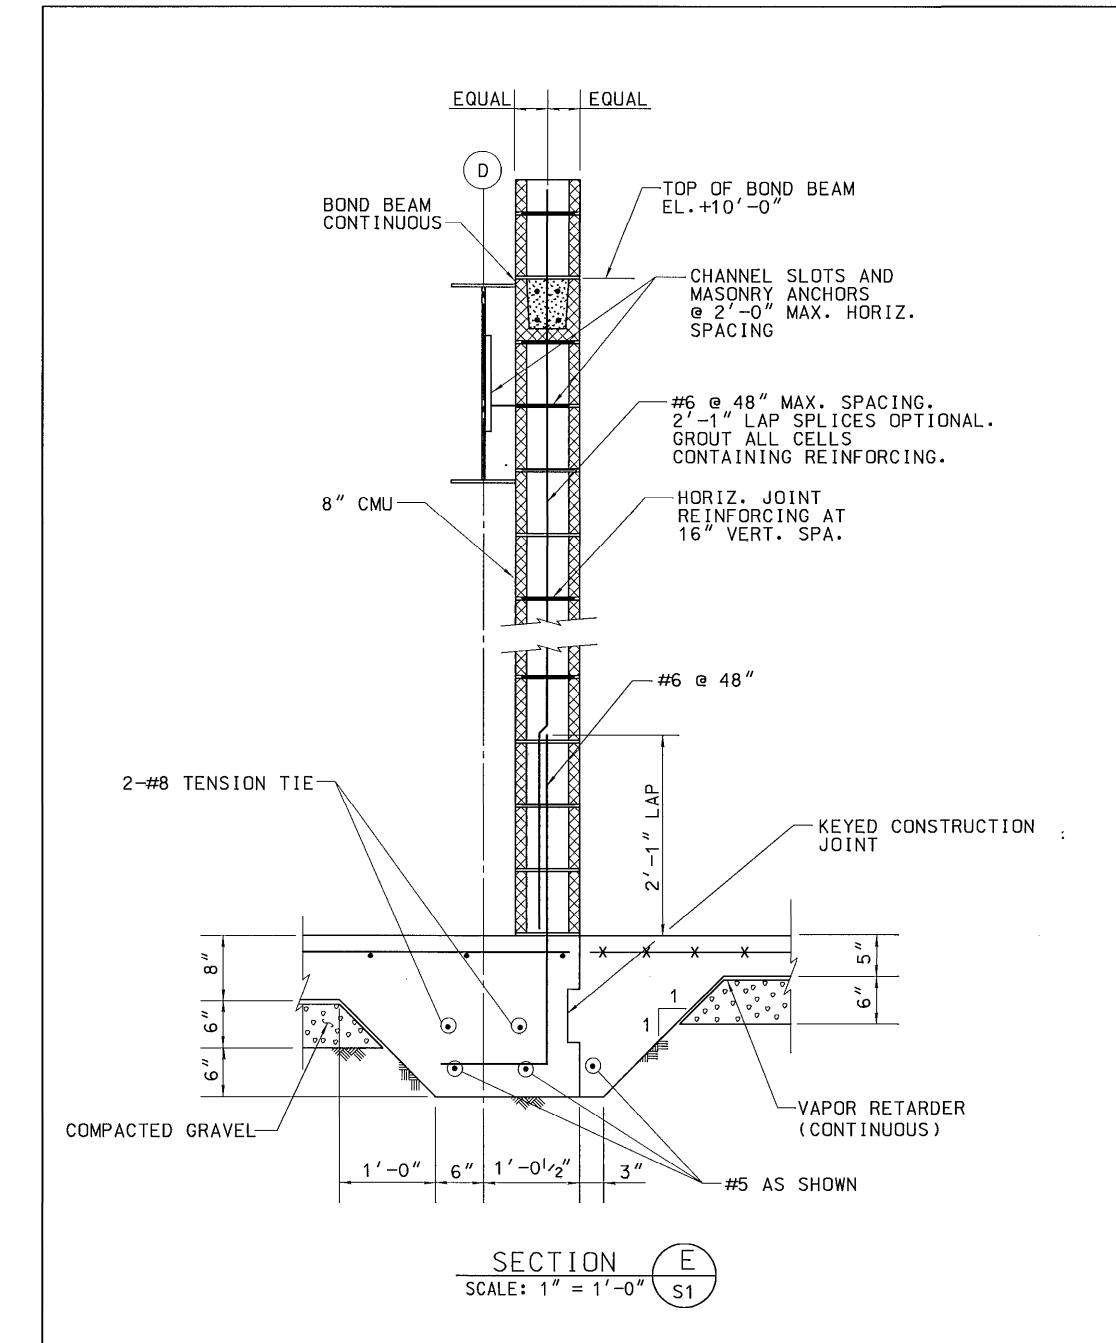

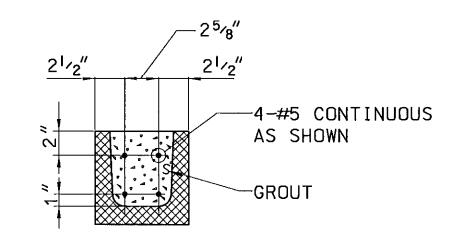


8" BOND BEAM / LINTEL DETAIL SCALE: 1 1/2"=1'-0"

MAINTENANCE BUILDING STRUCTURAL NOTES

- 1. CODES: MATERIALS AND CONSTRUCTION SHALL CONFORM TO THE FOLLOWING CODES AND STANDARDS AS APPLICABLE HOWARD COUNTY BUILDING CODE INTERNATIONAL BUILDING CODE (IBC), 2006 AMERICAN INSTITUTE OF STEEL CONSTRUCTION (AISC) MANUAL OF STEEL CONSTRUCTION-ALLOWABLE STRESS DESIGN (1989) AMERICAN CONCRETE INSTITUTE BUILDING CODE REQUIREMENTS FOR REINFORCED CONCRETE (ACI 318-05) AMERICAN CONCRETE INSTITUTE BUILDING CODE REQUIREMENTS FOR CONCRETE MASONRY STRUCTURES (ACI 530-05/ASCE 5-05/TMS 402-05) METAL BUILDING MANUFACTURER'S ASSOCIATION METAL BUILDING SYSTEMS MANUAL (2006)
- 2. DESIGN LOADS FOR PRE-ENGINEERED METAL BUILDING DEAD LOAD: ACTUAL CALCULATED DEAD LOAD ROOF LIVE LOAD: 30 PSF MINIMUM WITH NO REDUCTION SNOW LOAD: GROUND SNOW LOAD: 25 PSF SNOW EXPOSURE FACTOR: 0.9 SNOW LOAD IMPORTANCE FACTOR: 1.0 THERMAL FACTOR: 1.1 WIND LOAD BASIC WIND SPEED: 90 MPH WIND IMPORTANCE FACTOR: 1.00 WIND EXPOSURE: C INTERNAL PRESSURE COEFFICIENTS: +0.80, -0.30 COMPONENTS AND CLADDING: AS REQUIRED BY LOCATION SEISMIC SEISMIC USE GROUP: 1 SITE CLASS: D SPECTRAL RESPONSE COEFFICIENTS: SDS=0.203, SD1=0.101 DESIGN CATEGORY: A BASIC SEISMIC FORCE RESISTING SYSTEM: AS APPLICABLE DESIGN BASE SHEAR: AS APPLICABLE ANALYSIS PROCEDURE: AS APPLICABLE
- 3. FLOOR LIVE LOAD OFFICE AREA: 100 PSF MAINTENANCE BAY AREA: 250 PSF, AASHTO H-20
- 4. FOUNDATION DESIGN SOIL BEARING PRESSURE FOR SPREAD FOOTINGS AND STRIP FOOTINGS IS 2000 PSF FOUNDATION DESIGN LOADS: THE FOUNDATIONS SHOWN ON THE DRAWINGS ARE DESIGNED TO WITHSTAND THE FOLLOWING LOADINGS. IF THE BUILDING PROVIDED WOULD EXCEED THESE DESIGN LOADINGS, THE FOUNDATION SHALL BE REDESIGNED BY THE CONTRACTOR TO SUPPORT THE LOADING IMPOSED BY THE BUILDING PROVIDED.

TYPICAL FRAME 29.2 KIPS	END FRAME 19.5 KIPS	PORTAL FRAME 6.0 KIPS
22.0 KIPS	14.7 KIPS	5.2 KIPS
	,	0.0 KIPS
10.0 KIPS	10.0 KIPS	0.0 KIPS
TVDIOAL	END	DODT AL
		PORTAL
		FRAME
20.0 KIPS	20.0 KIPS	N / A
10.8 KIPS	10.8 KIPS	N / A
11.2 KIPS	11.2 KIPS	N / A
10.0 KIPS	10.0 KIPS	N / A
	FRAME 29.2 KIPS 22.0 KIPS 17.0 KIPS 10.0 KIPS TYPICAL FRAME 20.0 KIPS 10.8 KIPS 11.2 KIPS	FRAME 29.2 KIPS 19.5 KIPS 22.0 KIPS 14.7 KIPS 17.0 KIPS 10.0 KIPS 10.0 KIPS TYPICAL FRAME 20.0 KIPS 20.0 KIPS 10.8 KIPS 11.2 KIPS 11.2 KIPS

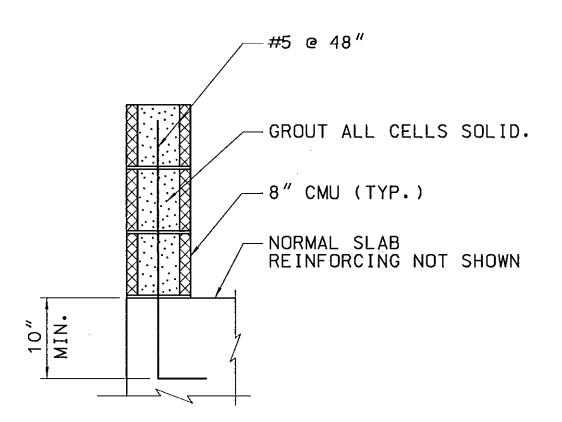

RETAINING WALL DETAIL SCALE: 1"=1'-0"

5. CONCRETE 28 DAY COMPRESSIVE STRENGTH, f'c: 3500 PSI REINFORCING STEEL BARS: ASTM A-615 GRADE 60 WELDED WIRE MESH: ASTM A-185 EXPOSED EDGES SHALL BE CHAMFERED 3/4" BY 3/4" UNLESS INDICATED OTHERWISE.

6. MASONRY MINIMUM COMPRESSIVE STRENGTH OF MASONRY: f'm: 1500 PSI HOLLOW CONCRETE MASONRY UNITS: ASTM C-90 SOLID CONCRETE MASONRY UNITS: ASTM C-145 MORTAR: PORTLAND CEMENT AND LIME, TYPE M OR S GROUT: ASTMC-476 COARSE GROUT, f'c = 3500 PSI AT 28 DAYS

7. STRUCTURAL AND MISCELLANEOUS METALS

BITUMASTIC PAINT

WIDE FLANGE BEAMS: ASTM A-992 CHANNELS, ANGLES PLATES AND SHAPES: ASTM A-36 OR ASTM A 572 GRADE 50 PIPE: ASTM A-53 GRADE B, TYPE E OR S TUBES: ASTM A-500, GRADE B HIGH STRENGTH BOLTS: ASTM A-325 COMMON BOLTS: ASTM A'-307 ANCHOR BOLTS AND THREADED RODS: ASTM A-36 WELDING SHALL CONFORM TO AMERICAN WELDING SOCIETY (AWS) STRUCTURAL WELDING CODE (D1.1) WELDING ELECTRODES: E70XX ALL ALUMINUM IN CONTACT WITH CONCRETE SHALL HAVE TWO COATS OF



George Vaeth Associates, Inc. Architecture • Interior Design 5501 Twin Knolls Rd., Suite 108 Columbia, Maryland 21045 Tel. (410) 997-1000 Fax (410) 997-2719 Email gvainc@gvaarchitects.com




KCI TECHNOLOGIES INC. **ENGINEERS • PLANNERS • SURVEYORS** 10 NORTH PARK DRIVE



Siegel, Rutherford, Bradstock, & Ridgway, Inc. CONSULTING ENGINEERS

> 757 Frederick Road, Suite 300 Catonsville, Maryland 21228 Phone (410) 869-7282 Facsimile (410) 869-7362 www.srbr.com

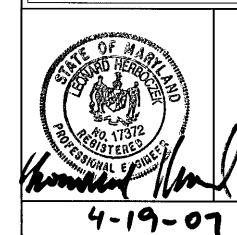

REVISIONS

NO. DATE DESCRIPTION


> NEW MAINTENANCE FACILITY ROCKBURN PARK FOR

HOWARD COUNTY PARKS & RECREATION

PROJECT NUMBER: 0503 4-10-06 PRELIMINARY ISSUE: CONSTRUCTION ISSUE: 08/18/06 CADD FILE NAME: 01053922\53

> STRUC TURAL NOTES

SHEET NUMBER:

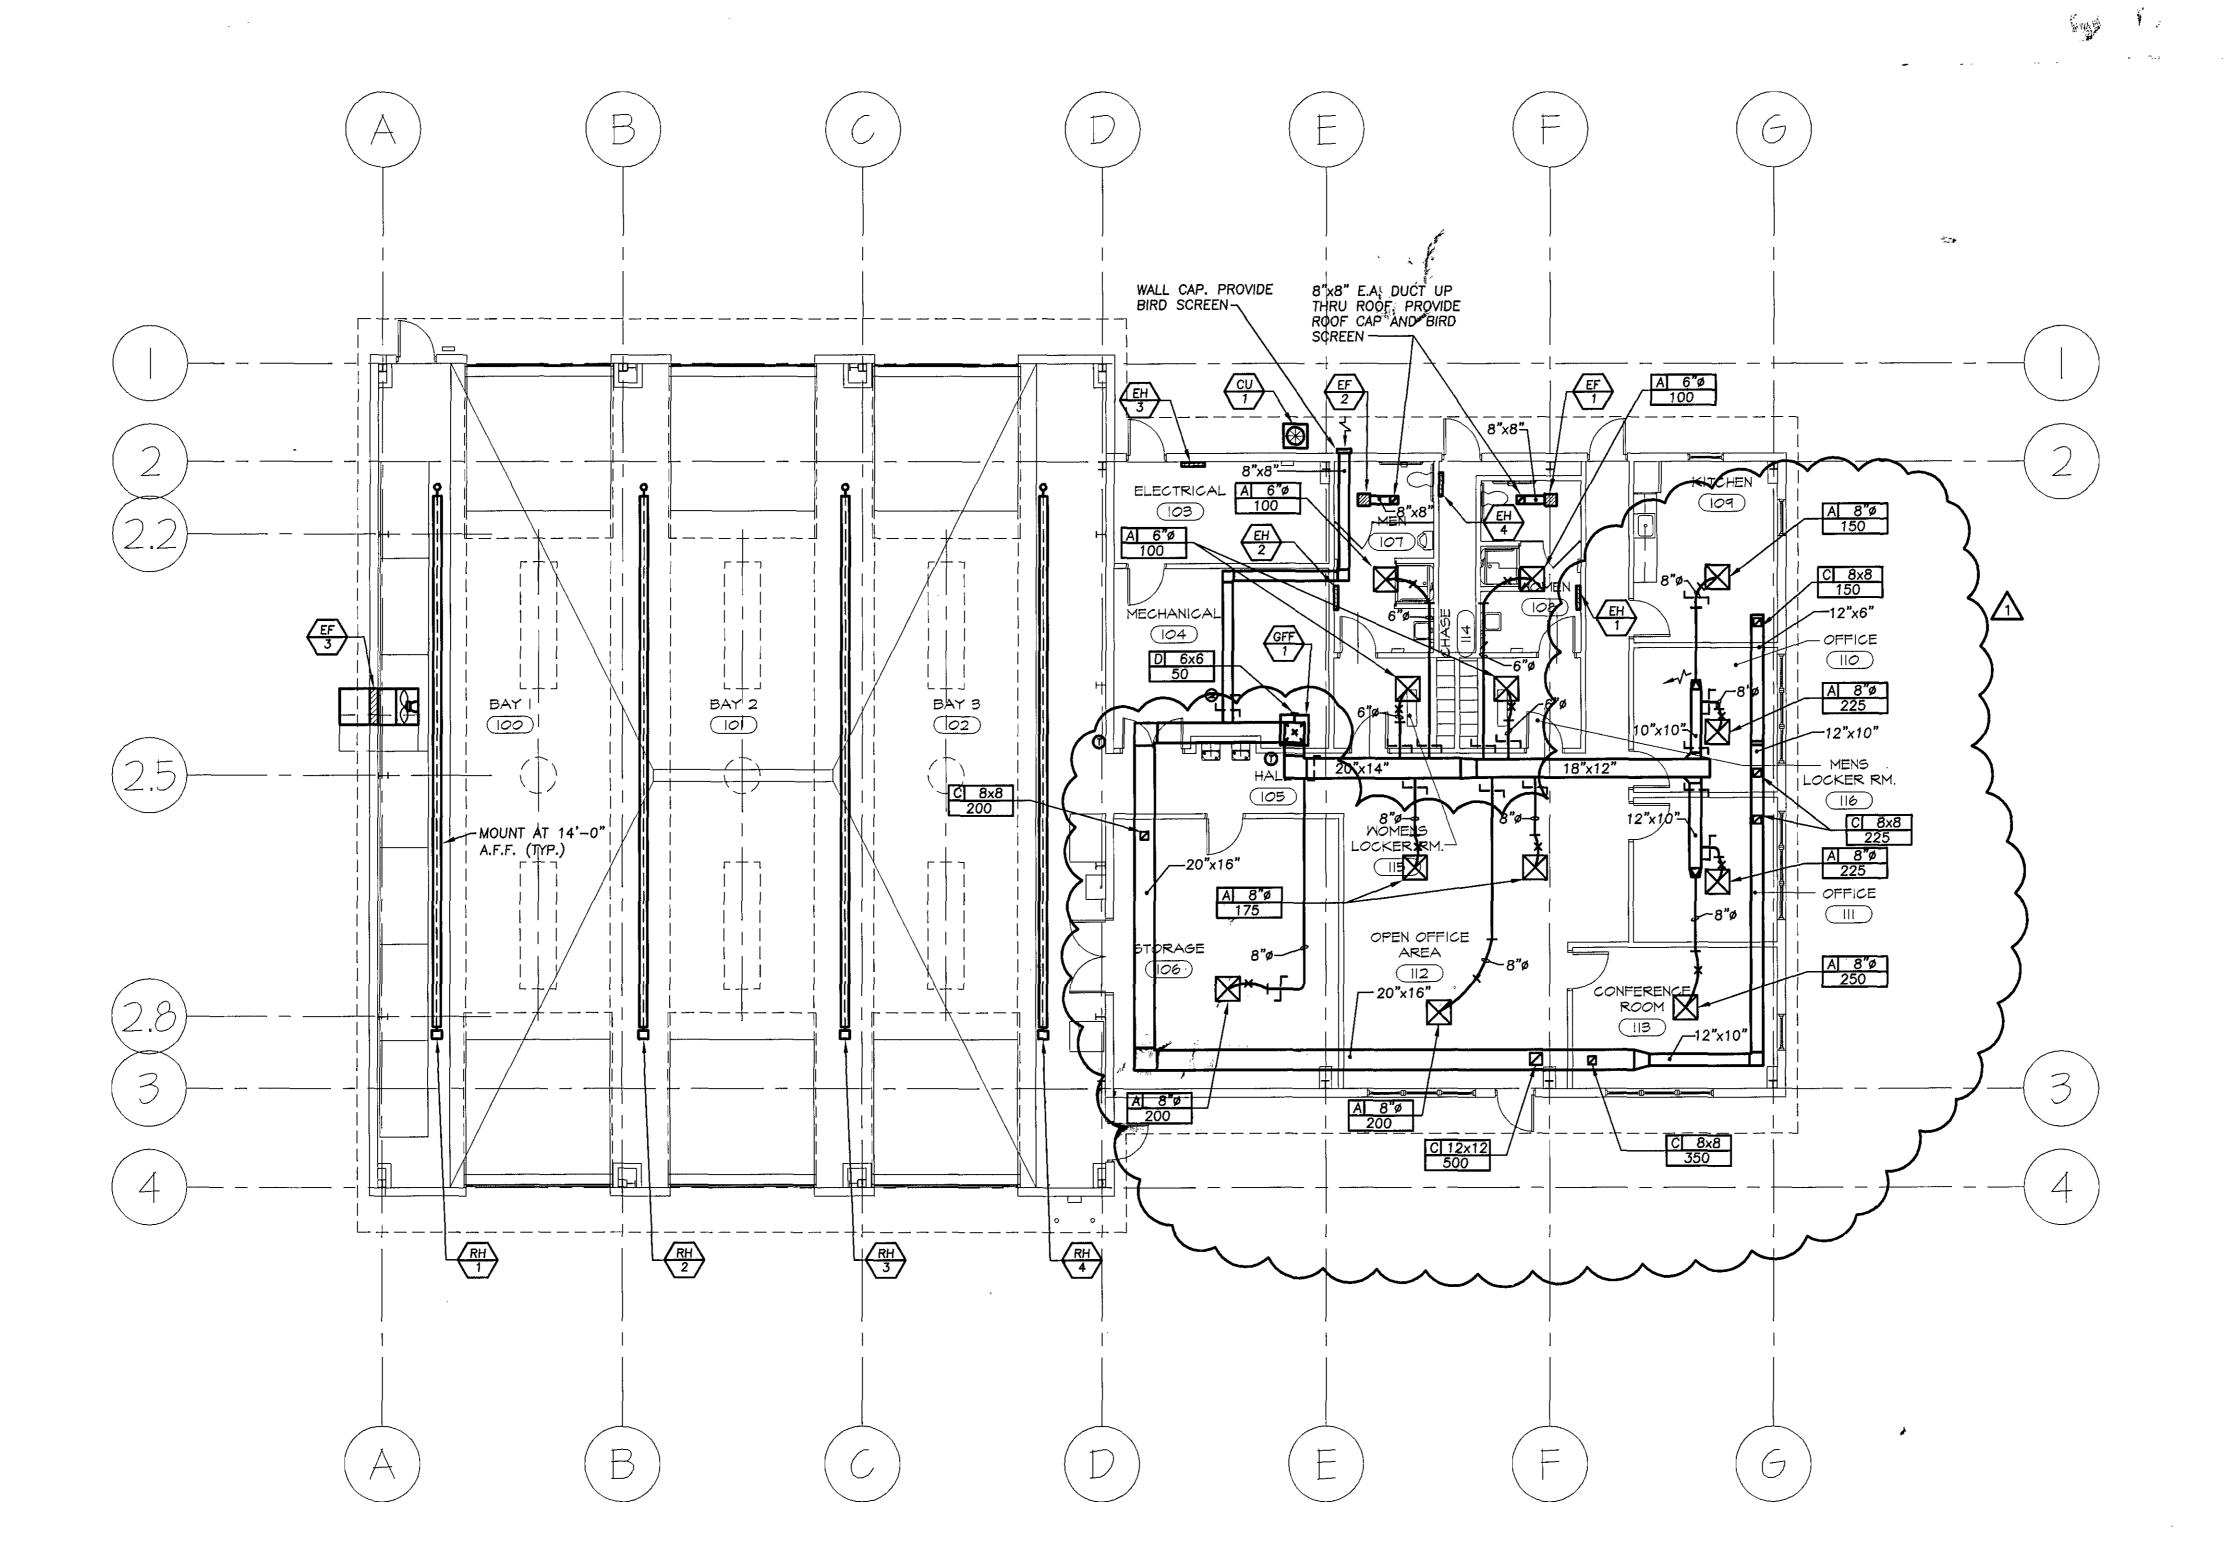

FLOOR PLAN - MECHANICAL

SCALE: 1/8" = 1'-0" 0 2' 4' 8' 16'



George Vaeth Associates, Inc. Architecture • Interior Design 5501 Twin Knolls Rd., Suite 108 Columbia, Maryland 21045 Tel. (410) 997-1000 Fax (410) 997-2719


Email gvalnc@gvaarchitects.com

KCI TECHNOLOGIES INC.
ENGINEERS • PLANNERS • SURVEYORS

10 NORTH PARK DRIVE
HUNT VALLEY, MD. 21030-1888
PHONE: (410) 316-7800 FAX: (410) 316-7817
WWW.KCLCOM

Siegel, Rutherford, Bradstock, & Ridgway, Inc.
CONSULTING ENGINEERS

757 Frederick Road, Suite 300
Catonsville, Maryland 21228
Phone (410) 869-7282
Facsimile (410) 869-7362
www.srbr.com

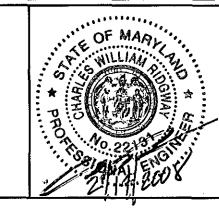

REVISIONS

NO. DATE DESCRIPTION
1 2/15/08 PERMIT COMMENTS

NEW
MAINTENANCE
FACILITY
ROCKBURN PARK
FOR
HOWARD COUNTY PARKS

& RECREATION

PROJECT NUMBER: 0503


PRELIMINARY ISSUE: 09/29/05

CONSTRUCTION ISSUE: 08/18/06

FLOOR PLAN
MECHANICAL

SHEET NUMBE

SHEET NUMBER

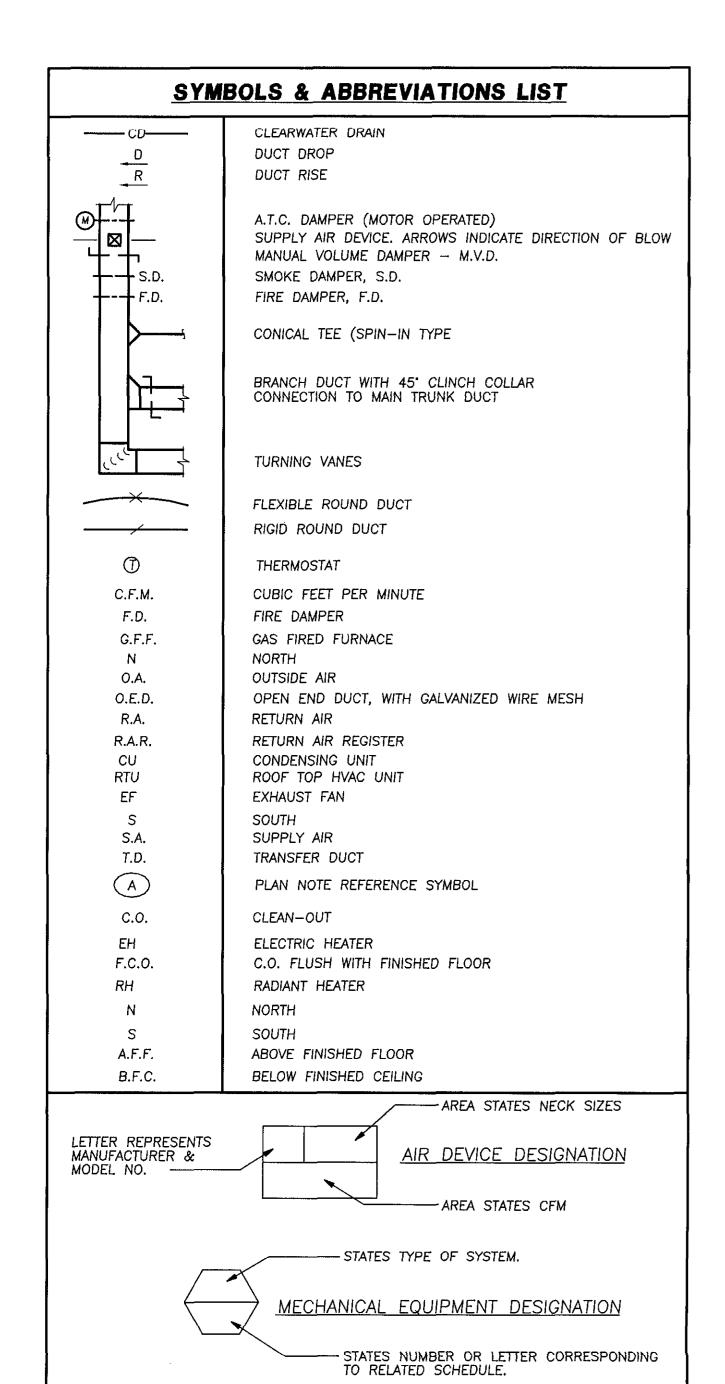

						GA	S-FI	RED F	URNA	CE	WIT	H D.X. CO	OLING COIL SCH	EDULE			
MADIA						FORCED	AIR FUI	RNACE						DIR	ECT EXPANSION COO	LING COIL	
MARK	AFUE	C.F.M.	OUTDOOR CFM	E.S.P.	CAPACITY INPUT	BTU/HR OUTPUT	H.P.	VENT SIZE	V-P-H	MCA	моср	MANUFACTURER & MODEL NO.	REMARKS	TYPE	COOLING CAPACITY BTU/HR	MANUFACTURER & MODEL NO.	REMARKS
GFF 1	93.1	2,000	200	0.5"	80,000	75,000	₹4	2"ø	120-1-60	18.4	20	'ESHVACCO'	FURNISH 2" CONCENTRIC ROOF TERMINATION KIT, FILTER RACK, FILTER AND THERMOSTAT.	HORIZONTAL FULLY CASED	54,500	"CARRIER" 'CD5AXA060024'	PROVIDE EXPANSION VALVE

MARK	SERVES	CFM	ESP	RPM	HP WATTS	V-P-H	DRIVE	MANUFACTURER & MODEL NO.	TYPE	CONTROL*	REMARKS
(EF)	WOMEN RESTROOM	250	1⁄8"	1000	- 83	120-1	DIRECT	"GREENHECK" 'SP-A250'	CEILING	WALL-SWITCH	SEE NOTES 1, 2, AND 3
EF 2	MENS RESTROOM	250	½"	1000	- 83	120-1	DIRECT	"GREENHECK" 'SP-A250'	CEILING	WALL-SWITCH	SEE NOTES 1, 2, AND 3
EF 3	BAYS	6240	1∕8"	610	1/3 _	120-1	BELT	"GREENHECK" 'SBE-1L30-3'	WALL PROP	T'STAT	SEE NOTES 1, 2, AND 4

		AIN CO	OLEL	CON	DENS	ING UNI	r schedui	<u>LE</u>
MARK	SERVES	TOTAL COOLING CAPACITY BTU/HR	SEER	M.C.A.	МОСР	V-P-H	MANUFACTURER & MODEL NO.	REMARKS
CU 1	SEE PLAN	54,500	10.5	37.4	60	208-1-60	"CARRIER" '38CKC060301'	PROVIDE REFRIGERANT LINE KIT AND HOUSEKEEPING PAD

	AIR DEVICE SCHEDULE									
MARK	SYSTEM	MANUFACTURER & MODEL NO.	REMARKS							
MAN	TYPE	MANOTACIONER & MODEL NO.	VEIMANAS							
	SUPPLY	"TITUS" - 'PAS' MODEL, 24"x24" CEILING MODULE, ALL	SEE PLAN FOR NECK SIZE.							
Α	DIFFUSER	STEEL CONSTRUCTION, STANDARD WHITE FINISH								
В	RETURN	"TITUS" 'PAR' MODEL, PERFORATED RETURN, 24"x24" CEILING MODULE, STANDARD WHITE FINISH	SEE PLAN FOR NECK SIZE.							
	GRILLE	CEILING MODULE, STANDARD WHITE FINISH								
С	TRANSFER	"TITUS" — 'PAR' MODEL, PERFORATED RETURN, 24"x24"	SEE PLAN FOR NECK SIZE.							
	GRILLE	CEILING MODULE, STANDARD WHITE FINISH								
	SUPPLY	"TITUS" - '300RL' SERIES, ALL STEEL CONSTRUCTION,	SEE PLAN FOR SIZE.							
D	REGISTER	STANDARD WHITE FINISH								

ELECTRIC HEATER SCHEDULE									
I ARK	TYPE	WATTS	BTU/HR	V-P-H	MANUF. & MODEL NO.	REMARKS			
EH 1	RECESSED	2,000	6,826	208-1-60	"Q-MARK" 'AWH-4405-2'	1			
EH 2	RECESSED	2,000	6,826	208-1-60	"Q-MARK" 'AWH-4405-2'	1			
EH 3	RECESSED	2,000	6,826	208-1-60	"Q-MARK" 'AWH-4405-2'	1			
EH 4	UTILITY	500	1,706	120-1-60	"Q-MARK" 'HUT500'	1			

MARK	SERVES	INPUT BTU/HR	MANUFACTURER & MODEL NO.	AMPS	V-PH	REMARKS
RH 1	BAYS	100,000	"AMBI-RAD" 'PT100'	1.4	120-1-60	PROVIDE TURBULATOR IN LAST 6' OF TUBE, FLUE, MOUNT 14'-0" A.F.F.
RH 2	BAYS	100,000	"AMBI-RAD" 'PT100'	1.4	120-1-60	PROVIDE TURBULATOR IN LAST 6' OF TUBE, FLUE, MOUNT 14'-0" A.F.F.
RH 3	BAYS	100,000	"AMBI-RAD" 'PT100'	1.4	120-1-60	PROVIDE TURBULATOR IN LAST 6' OF TUBE, FLUE, MOUNT 14'-0" A.F.F.
RH 4	BAYS	100,000	"AMBI-RAD" 'PT100'	1.4	120-1-60	PROVIDE TURBULATOR IN LAST 6' OF TUBE, FLUE, MOUNT 14'-0" A.F.F.

George Vaeth Associates, Inc. Architecture Interior Design 5501 Twin Knolls Rd., Suite 108 Columbia, Maryland 21045

Tel. (410) 997-1000 Fax (410) 997-2719

Emall gvalnc@gvaarchitects.com





Siegel, Rutherford, Bradstock, & Ridgway, Inc.

CONSULTING ENGINEERS

757 Frederick Road, Suite 300 Catonsville, Maryland 21228 Phone (410) 869-7282 Facsimile (410) 869-7362 www.srbr.com



08-18-06

REVISIONS
NO.DATE DESCRIPTION

NEW
MAINTENANCE
FACILITY
ROCKBURN PARK
FOR

HOWARD COUNTY PARKS & RECREATION

PROJECT NUMBER: 0503

PRELIMINARY ISSUE: 09/29/05


CONSTRUCTION ISSUE: 08/18/06

CADD FILE NAME:

MECHANICAL SCHEDULE


SHEET NUMBER:

CONSTRUCTION ISSUE 08/18/2006 SRBR No: 05089 M-2

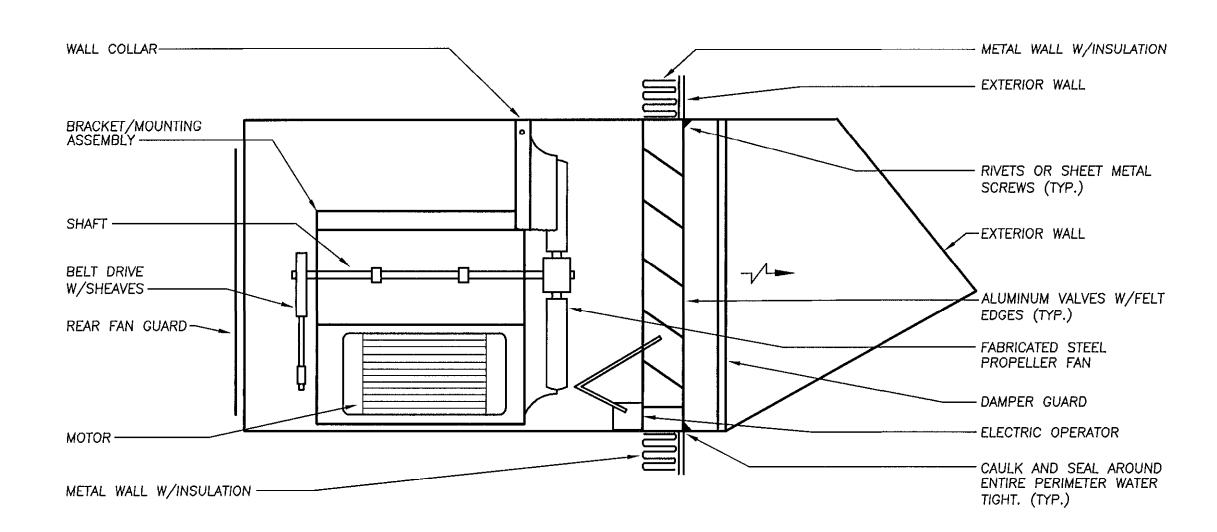


WALL MOUNTED PROPELLER TYPE EXHAUST FAN DETAIL

NO SCALE

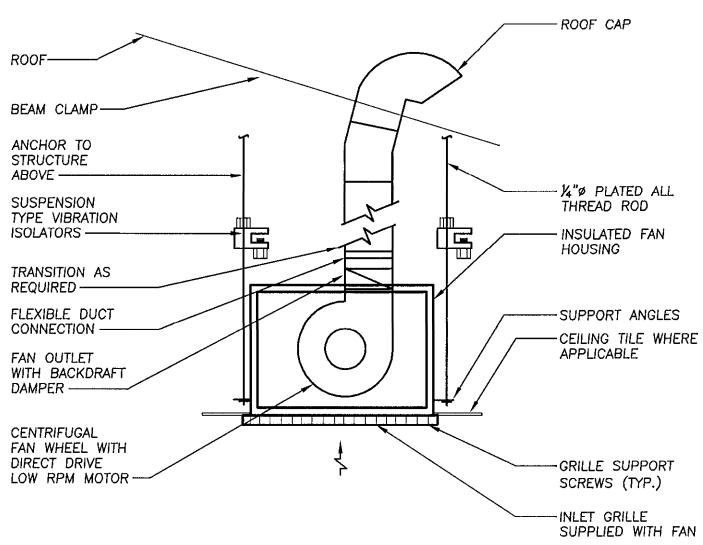

CEILING MOUNTED EXHAUST FAN WITH ROOF CAP DETAIL NO SCALE

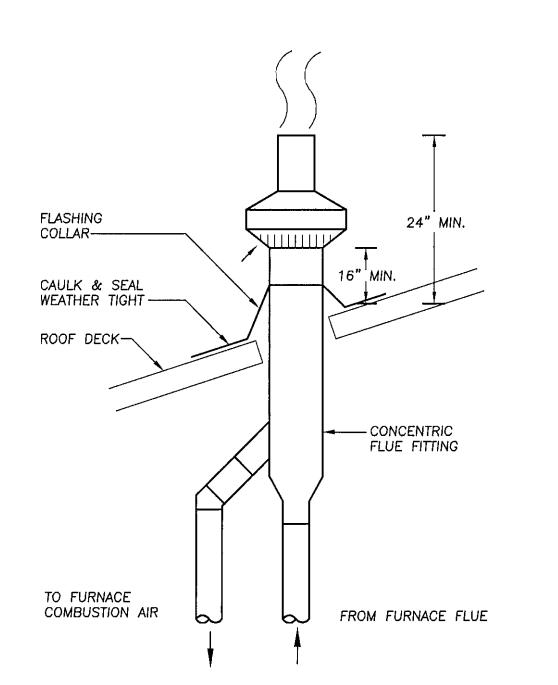

CONCENTRIC FLUE/INLET VENT DETAIL

NO SCALE

NOTE: SUPPORT FLUE FITTING, VENT & COMBUSTION AIR PIPING FROM STRUCTURE AS REQUIRED.

1. GENERAL

 A. The GENERAL AND SPECIAL CONDITIONS shall govern this work as they apply.

2. SCOPE

A. A. Mechanical work includes labor, materials and equipment, machinery and services necessary to provide complete heating, cooling and ventilating systems as hereinafter specified and shown on drawings, including layout of work and coordination of work with that specified elsewhere.

B. Work includes, but is not limited to the following:

- 1. HVAC installation.
- All required temperature controls.
 All ductwork and ventilation indicated.
- All ductwork and ventilation indicated.
 Balancing of heating, air conditioning and ventilation systems to design parameters.

3. GENERAL REQUIREMENTS

- A. All work shall be in accordance with the requirements of the applicable Building Code and all other regulatory bodies or agencies having jurisdiction. All systems shall be complete. The Contractor shall do all excavation and back filling necessary to install underground piping included under this section.
- B. Contractor shall obtain and pay for all permits, licenses and inspections required under this section.
- C. The Contractor shall guarantee all materials and workmanship against defects for a period of one year after final acceptance of the work.
- D. Unless noted otherwise, all material shall be new and shall bear the Underwriter's Label where applicable.
- E. All work shall be subject to the requirements of all sections that may interlock with this section in any way.
- F. Electrical work performed under this Section shall comply with the requirements set forth under the "ELECTRICAL WORKS" Section. All motors ½hp and over, shall generally be wound for 208-volt, 3-phase, 60-cycle current, unless otherwise noted.
- G. Provide all foundations and supports for equipment furnished under this section. Equipment mounted outside shall be placed on a 5" concrete pad.

4. COORDINATION OF TRADES:

- A. The Subcontractor shall give full cooperation to other trades and shall furnish in writing, with copies to the Architect, any information necessary to permit the work of the trades to be installed in proper sequence and with the least possible interference or delay.
- B. If the Subcontractor install his work without coordinating with other trades, and the installation interferes with their installation, he shall make any changes necessary in this work to correct the condition without extra charge to the owner.
- C. If so directed by the Architect, the Subcontractor shall provide dimensioned fabrication drawings of critical areas, at not additional cost to the owner.

5. MATERIAL LIST AND SHOP DRAWINGS:

- A. Contractor shall submit a complete list of material and equipment for approval by Engineer with 30 days of contract date. The list shall describe type of material, capacities and catalog numbers of equipment, and give such information as necessary for checking equipment for approval.
- B. Contractor shall submit detailed shop drawings of all work and equipment for approval by the Architect and Engineer. Shop drawings shall give all pertinent information, and shall be properly checked and coordinated with other work before submission. No work shall be performed, save at Contractor's own risk, until applicable shop drawings and layout drawings have been approved. All substitute equipment shall be marked "substitute manufacturer".
- C. Any changes in any trade brought about by substitutions of specified equipment shall be done at no charge to the contract price and shall be fully coordinated with all other trades. The Contractor must indicate any and all cost credits associated with using substitute equipment.

MECHANICAL SPECIFICATIONS

6. **GUARANTEE AND SERVICE:**

- A. Contractor shall guarantee all materials and workmanship for a period of one year after date of acceptance, and shall repair or replace, at no additional cost to the Owner, any part thereof which may become defective within guarantee period, ordinary wear and tear excepted. Contractor shall be responsible for and pay for any damages caused by or resulting from defects of his work.
- B. Contractor shall provide five—year warranty on all new compressor units.
- C. Contractor shall provide free service, inspection and adjustment of complete system and all necessary balancing and adjustments for one year beginning from the date of acceptance.

7. BALANCING AND CHECKING OF SYSTEMS:

- A. Provide all testing of all equipment; adjust operation of equipment so that all systems shall be left in perfect operating condition. All testing shall be performed during extremes of weather, as well as during intermediate seasons. All systems shall be balanced. Provide all instruments required for such test. Temperature, air supply and exhaust quantities shall be measured and tabulated for each supply and exhaust register, diffuser, or grille. Tabulation shall be submitted to the Architect.
- B. Total System Balanced shall be performed by an agency certified by the Associated Air Balance Council (AABC) and approved by the Owner's Representative. All work done by this agency shall be by qualified Technicians under the direct supervision of an AABC Certified Test and Balance Engineer. NEBB certified test and balancing agencies may be considered provided to comply with.
- C. Total System Balance shall be performed in accordance with the latest edition of the AABC National Standards, for Total system Balance, and in accordance with the scope of the work specified.
- D. Upon the completion of the work, the Test and Balance Agency shall submit 4 copies of the complete Test and Balance Report to the Engineer for review.

8. INSTRUCTIONS:

- A. Contractor shall provide Owner with two copies of the instructions and maintenance charts, giving detailed information on operation and maintenance of heating and cooling.
- B. The Contractor shall provide a minimum of 4 hours of training to the Owner. Training shall include general operation and preventive maintenance procedures for all mechanical and plumbing systems, and equipment, including temperature controls systems.

9. CLEANING OF EQUIPMENT AND WORK AREAS:

A. Upon completion, all equipment and work area shall be thoroughly cleaned, filters replaced with new, ready for use.

10. INSULATION FOR DUCTWORK:

A. All new concealed supply and return ductwork shall be covered with 1" duct insulation with vapor barrier jacket. All insulation joints shall be vapor sealed.

11. HEATING AND AIR CONDITIONING UNITS:

- A. Provide all Mechanical Equipment as specified.
- B. Provide all required vibration isolation to prevent transfer of objectionable noise and vibration to the building structure.
- C. Provide proper drainage of condensate per local
- D. Coordinate all electrical connection requirements with Division 16.
- E. All equipment shall be by one of the specified
- F. Provide all devices and wiring necessary for proper control of each system.

12. AUTOMATIC TEMPERATURE CONTROLS:

manufacturers.

A. HVAC Systems: Provide new 7—day programmable thermostat compatible with units shown on plans.

13. DUCTWORK:

A. All ductwork shall be galvanized sheetmetal of the following thickness unless noted otherwise:

Max. duct dimension Low Pressure
12" 26 ga.
13" to 30" 24 ga.
Plenums and Casings 16 ga.

- B. Provide fire dampers as shown and required. Fire dampers shall be equal in rating to the surfaces being protected and shall be UL listed. All fire dampers shall be type 'B' accordion type with fusible link. The damper shall contain a pocket to keep the damper out of the air stream in its open positing. Provide access panels for all fire dampers as needed.
- C. All metal ductwork shall be constructed and installed in accordance with Sheet Metal and Air Conditioning Contractor's Association "Low Pressure Duct Standards", and shall be air—tight and neat in appearance. Cross—joints in all low pressure ducts, supply, return and exhaust, shall be sealed with fire retardant sealer. Duct tape shall not be used. Interior surfaces shall be smooth and free of obstructions. All duct lines shall be true and smooth. Where exposed ducts pass through openings in partitions and ceilings, they shall be fitted with trim angles to close joints between duct and construction.
- D. Furnish and install volume control dampers with locking facilities, splitters, and other devices at all locations indicated on drawings and where required to properly balance the systems and to deliver the air quantities of proper size.
- E. Turning vanes shall be provided for all supply air square elbows and shall be acoustical type.

14. REGISTERS, GRILLES AND DIFFUSER:

- A. Registers, grilles and diffusers, hereafter specified, refer to Price MFG. catalog. Equipment of equal quality as manufactured by "Titus, Tuttle & Bailey or Metalaire may be submitted for approval.
- B. All supply, return and exhaust registers shall be steel registers with volume dampers. Unless otherwise indicated.



George Vaeth Associates, Inc., Architecture • Interior Design 5501 Twin Knolls Rd., Suite 108 Columbia, Maryland 21045


Tel. (410) 997-1000 Fax (410) 997-2719 Email gvainc@gvaarchitects.com





CONSULTING ENGINEERS
757 Frederick Road, Suite 300
Catonsville, Maryland 21228
Phone (410) 869-7282
Facsimile (410) 869-7362

www.srbr.com

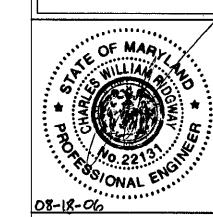

REVISIONS

NO. DATE DESCRIPTION

MAINTENANCE
FACILITY
ROCKBURN PARK
FOR

NEW

HOWARD COUNTY PARKS & RECREATION

PROJECT NUMBER: 0503

PRELIMINARY ISSUE: 09/29/05


CONSTRUCTION ISSUE: 08/18/06

MECHANICAL SPECIFICATIONS &

SHEET NUMBER:

M-3

DETAILS

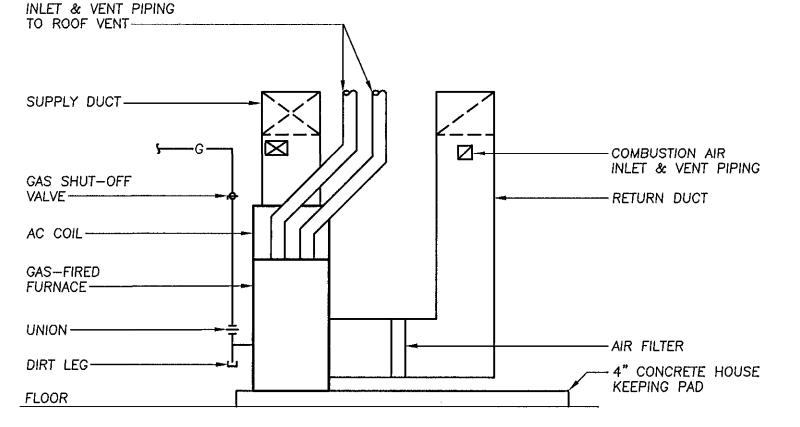

FURNACE DETAIL


NO SCALE

COMBUSTION AIR

CONSTRUCTION ISSUE 08/18/2006

SRBR No: 05089

280F 38

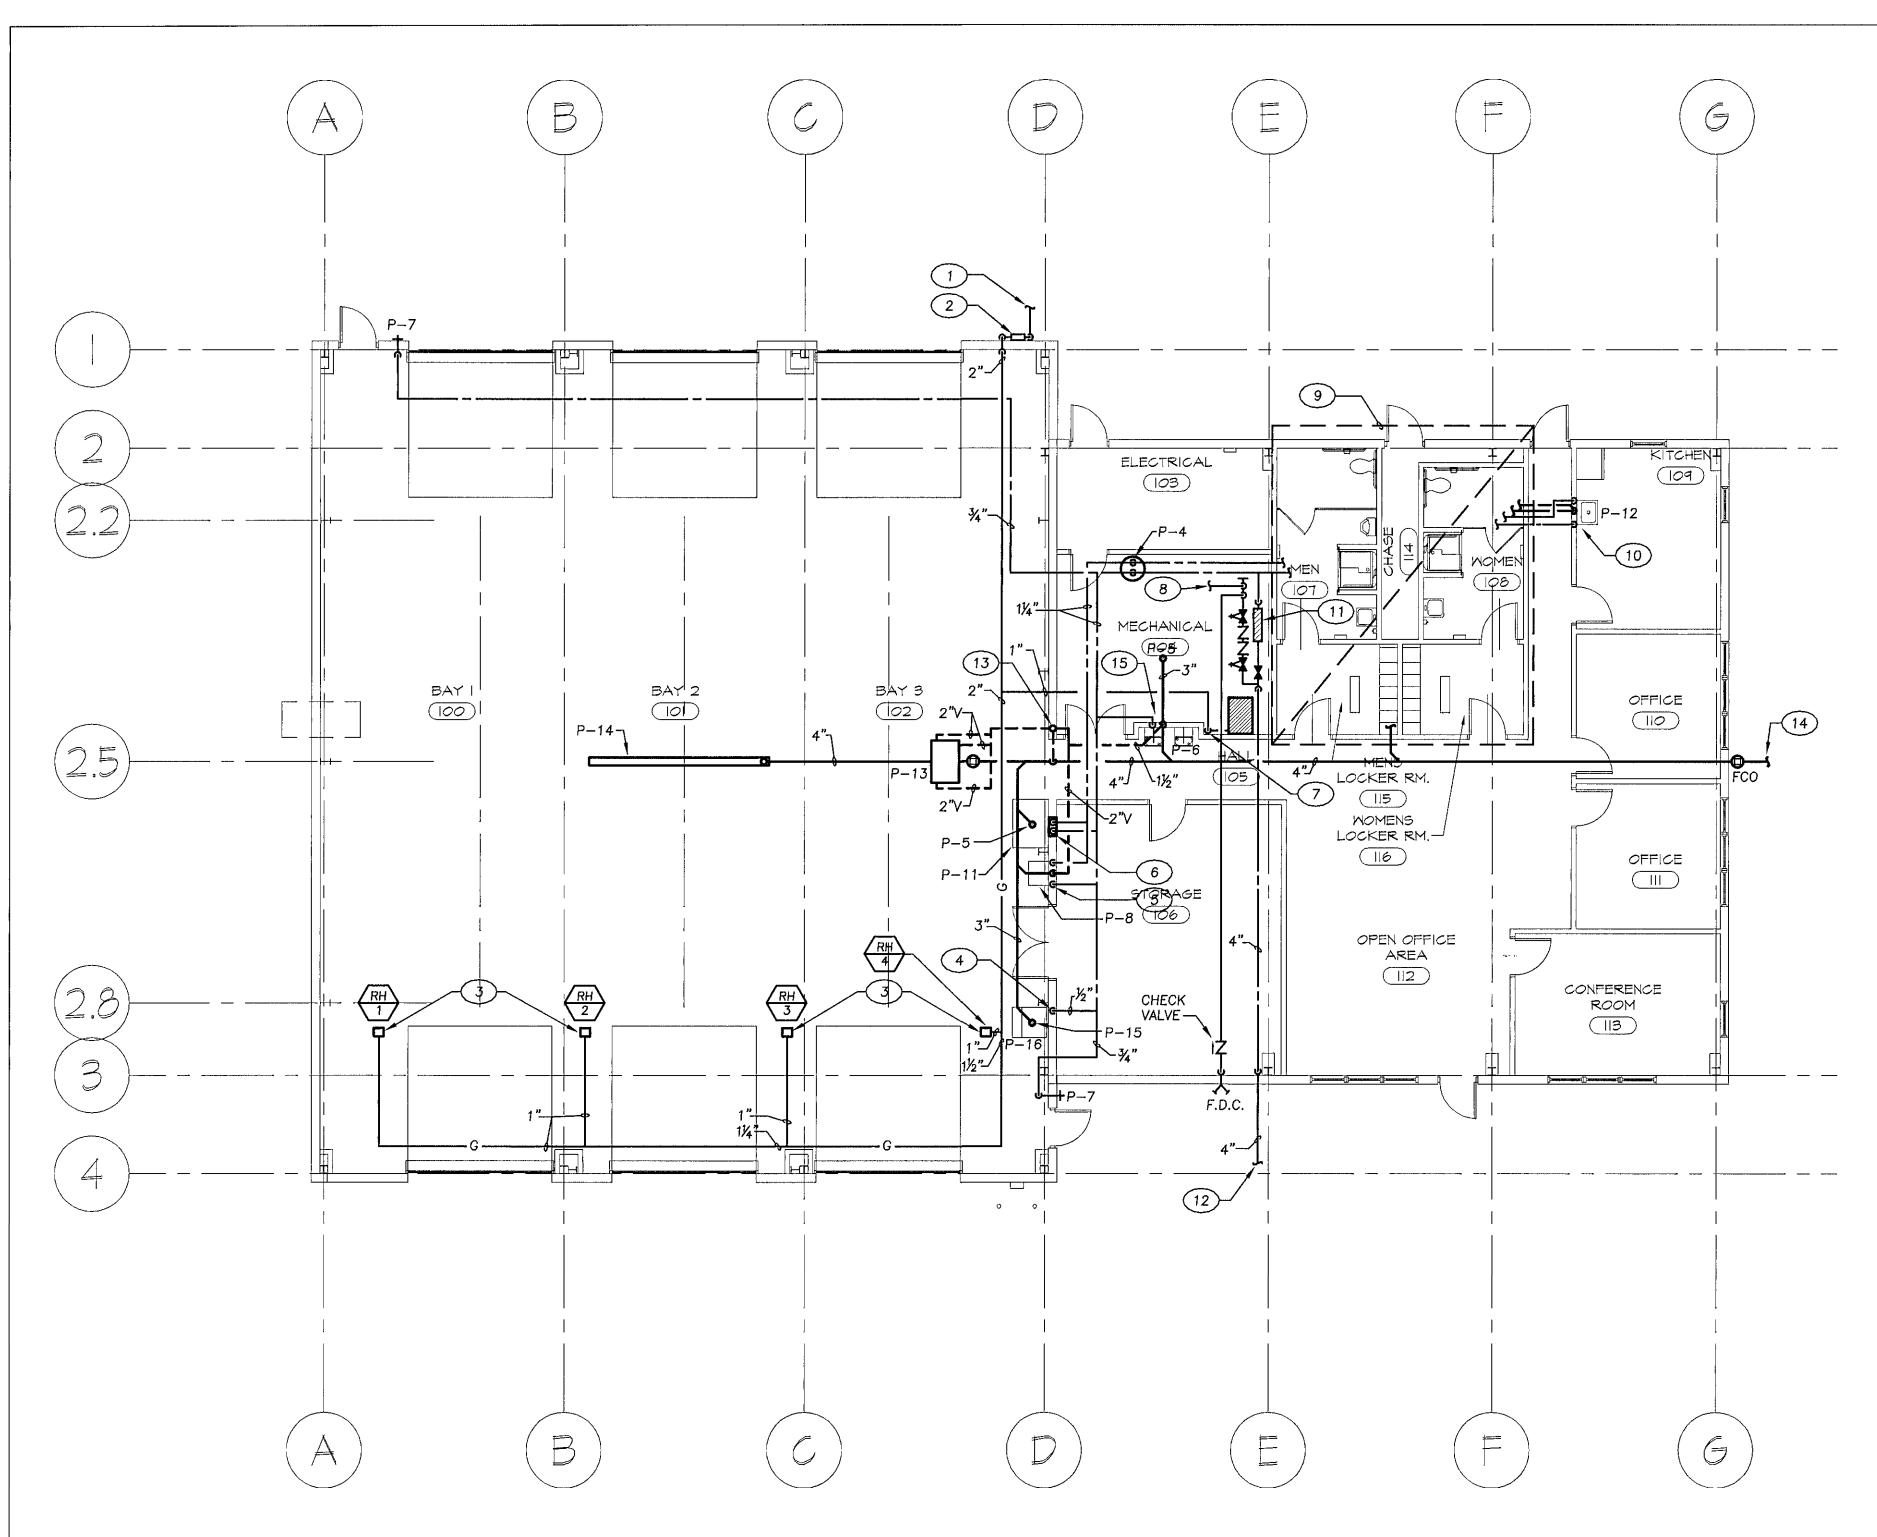


FLOOR PLAN - PLUMBING

SCALE: 1/8" = 1'-0"
0 2' 4' 8' 16'

PLAN NOTES:

- 1 INCOMING GAS SERVICE. SEE CIVIL DWGS. FOR CONTINUATION.
- 2 GAS METER PROVIDED BY LOCAL UTILITY CO. TO HANDLE EST. LOAD 480 CFH AT 120' PIPE EQUIVALENT LENGTH, 0.3" P.D.
- 3 1" GAS TO RADIANT HEATER. PROVIDE SHUT-OFF VALVE AND 6" DIRT LEG.
- 4 1/2" CW DOWN TO ICE MACHINE.
- 5 ½" CW, HW, 2" VENT DOWN IN WALL TO SERVICE SINK. 3" SAN UP.
- 6 14" CW, HW DOWN IN WALL TO EMERGENCY SHOWER.
- 7 1" GAS DOWN TO FURNACE. PROVIDE SHUT-OFF VALVE AND 6" DIRT LEG.

- (8) TO SPRINKLER ZONES.
- 9 SEE 14" SCALE DWG. ON THIS SHEET FOR WORK IN THIS AREA.
- 10 1/2" CW, HW, 11/2" VENT DOWN IN WALL TO KITCHEN SINK.
 11/2" SAN UP.
- 11) VALVE AND METER ASSEMBLY SEE P-3 FOR DETAIL.
- 4" INCOMING DOMESTIC WATER/SPRINKLER SERVICE. SEE CIVIL DWG. FOR CONTINUATION.
- 13) 3" VENT THRU ROOF, DOWN IN WALL.
- 4" SAN 5FT. FROM BUILDING. SEE CIVIL DWG. FOR CONTINUATION.
- 15 1/2" CW, 2" VENT DOWN IN WALL TO WATER COOLER. 2" SAN UP.

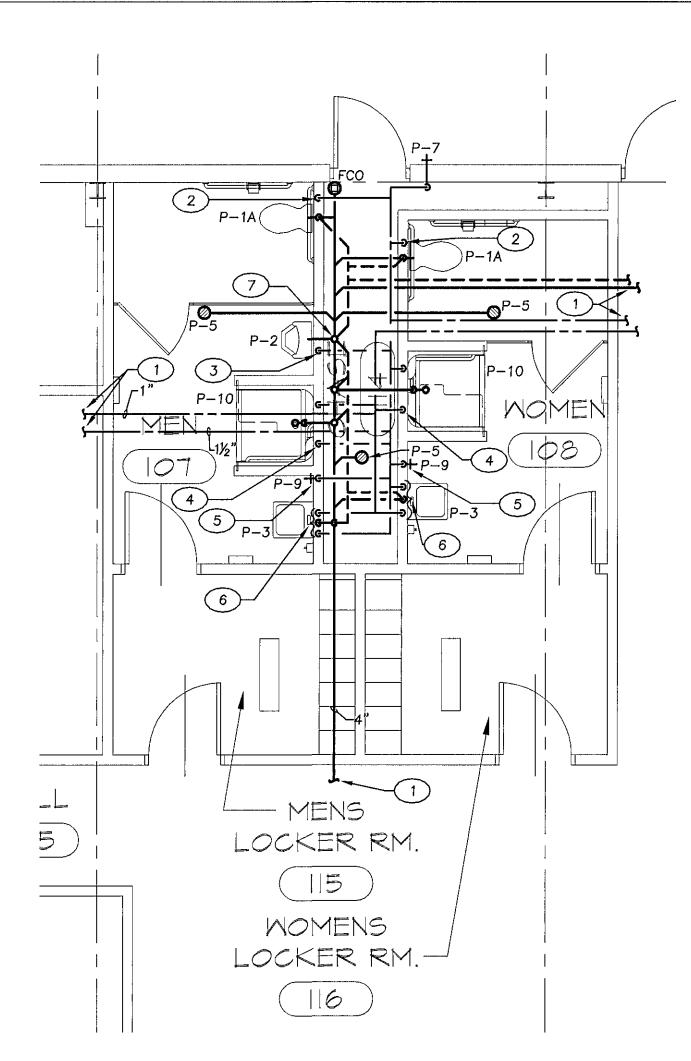

1/4" SCALE PART PLAN

SCALE: 1/4" = 1'-0" 0 1' 2' 4'

PLAN NOTES

- 1 SEE %" SCALE DWG. ON THIS SHEET FOR CONTINUATION.
- 2 1½" CW DOWN TO WATER CLOSET.
- 3 1" CW DOWN TO URINAL.
- 4 1/2" CW, HW, 2" VENT DOWN IN WALL TO SHOWER.
- 5 34" CW DOWN IN WALL TO HOSE BIBB.
- 6 1/2" CW, HW, 2" VENT DOWN IN WALL TO LAVATORY.
- 7 3" VENT THRU ROOF, DOWN IN CHASE.






KCI TECHNOLOGIES INC. ENGINEERS • PLANNERS • SURVEYORS

IO NORTH PARK DRIVE
HUNT VALLEY, MD. 20030-1888
PHONE: (410) 316-7800 FAX: (410) 316-7817
WWW.KCLCOM



Siegel, Rutherford, Bradstock, & Ridgway, Inc.
CONSULTING ENGINEERS

757 Frederick Road, Suite 300 Catonsville, Maryland 21228 Phone (410) 869-7282 Facsimile (410) 869-7362 www.srbr.com

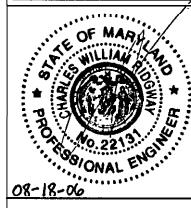

REVISIONS

NO. DATE DESCRIPTION

NEW
MAINTENANCE
FACILITY
ROCKBURN PARK

HOWARD COUNTY PARKS & RECREATION

PROJECT NUMBER: 0503

PRELIMINARY ISSUE: 09/29/05

CONSTRUCTION ISSUE: 08/18/06

CADD FILE NAME:

FLOOR PLAN PLUMBING

SHEET NUMBER:


CONSTRUCTION ISSUE 08/18/2006

		. ,		<u> </u>		PLUMBING FIXTURE				
DESIG	FIXTURE TYPE	нw	CW	SAN	VENT	SPECIFICATIONS	REMARKS			
P-1A	WATER CLOSET	–	1 ½"	3"	_	"KOHLER" NO. 'K4460-C': WALL HUNG, ELONGATED BOWL, AND 1.6 GPF. FURNISH W/ "SLOAN" FLUSH VALVE MODEL NO. 'REGALC152-1.6'	1,2,4,6,10			
P-2	URINAL	-	1"	3"	2"	"KOHLER" MODEL NO. 'K-4989-R', SIPHON-JET FLUSHING ACTION, VITREOUS CHINA 1 GPF. FURNISH W/ "SLOAN" FLUSH VALVE 'REGAL 190-1'	1,10,2			
P-3	LAVATORY	1/2"	1/2"	1 ½"	1 ½"	"KOHLER" MODEL NO. 'K-1729', 4" CENTER, FURNISH WITH "SLOAN" FAUCET MODEL NO. 'ETF600'	1,2,3,10			
P-4	WATER HEATER	3/4"	3/4"	_		MODEL NO. 'CPE-50-20RTA'				
P-5	FLOOR DRAIN	_	_	3"	_	"JOSAM" MODEL NO. '30000A'	1,5,10			
P-6	ELECTRIC WATER COOLER		1/2"	1 ½"	1 ½"	"OASIS" MODEL NO. 'P8AMSL', 8.0 GPH, ¼HP COMP., 4.6 AMPS, 120V-1P-60H	1,9,10			
P-7	WALL HYDRANT	_	3/4"	_	_	"JOSAM" MODEL NO. '71050'	1			
P-8	SERVICE SINK	1/2"	1/2"	3"	2"	"KOHLER" MODEL NO. '6718' FURNISH WITH "KOHLER" FAUCET NO. 'K-8907-RP'	1,10			
P-9	HOSE-BIBB	_	3/4"		_	"JOSAM" MODEL NO. '71070'	1			
P-10	SHOWER	1/2"	1/2"	2"	_	"COMFORT DESIGN" MODEL NO. 'XST—3938—BF—5'. FURNISH WITH HAND HELD SHOWER KIT, PRESSURE BALANCING VALVE.	1,2,10			
P11	EMERGENCY SHOWER/EYE WASH	1 1/4"	1 1/4"	_	2"	"BRADLEY" MODEL NO. '519-31000' FURNISH WITH THERMOSTATIC MIXING VALVE: "LAWLER" NO. '8334'	1,10			
P-12	KITCHEN SINK	1/2"	1/2"	1 ½"	1 ½"	"ELKAY" MODEL NO. 'DCR-252210', STAINLESS STEEL, 25"X22"X10" DEEP. FURNISH WITH "ELKAY" FAUCET 'LK-2445BH'	1,10			
P-13	OIL WATER SEPARATOR		-	3"	-	"ROCKFORD" MODEL NO. 'OST-5628'				
P-14	TRENCH DRÁIN	_	_	4"		"JOSAM" MODEL NO. '76010' 15'-0" TOTAL LENGTH	1			
P-15	FLOOR DRAIN	-		3	_	"JOSAM" MODEL NO. '30000E1'	1			
P-16	ICE MACHINE	-	1/2"			"SCOTSMAN" MODEL NO 'SLE300AS—1A': STAINLESS STEEL FINISH, 115V—1P—60H, ¾HP COMPRESSOR, 19.7 MCA, 20 MOCP. FURNISHED COMPLETE WITH STORAGE BIN 'SLB—150'				

- 1. PROVIDE ALL REQUIRED COMPONENTS FOR COMPLETE ROUGH-IN. I.E. SUPPLIES, STOPS, TRAPS, CARRIERS, GRID DRAIN, TAIL PIECES, ETC.
- 2. FIXTURES SHALL BE ADA COMPLIANT. PROVIDE WITH ADA COMPLIANT ACCESORIES, MOUNT ADA COMPLIANT, SEE ARCHTIECTURAL PLAN FOR ELEVATIONS.
- 4. COORDINATE VALVE SENSOR INSTALLATION WITH ADA GRAB BAR. SENSOR SHALL BE LOCATED SO
- THAT GRAB BAR DOES NOT INTERFERE WITH OPERATION.


3. PROVIDE 'SKAL-GUARD' INSULATIONS DEVICES ON EXPOSED UNDERCOUNTER PLUMBING.

- 5. PROVIDE DEEP SEAL TRAP.
- 6. PROVIDE APPROVED ELONGATED OPEN FRONT TOILET SEAT.
- 7. PROVIDE "SLOAN" 'EL-206' TRANSFORMER(S) AS REQUIRED.
- 8. WATER HEATER 50 GALLON, 4.5KW, 240V-1P-60H, STATE OR APPROVED EQUAL.
- 9. EWC TO BE ADA COMPLIANT.
- 10. SEE PLAN AND RISER FOR VENT SIZES,

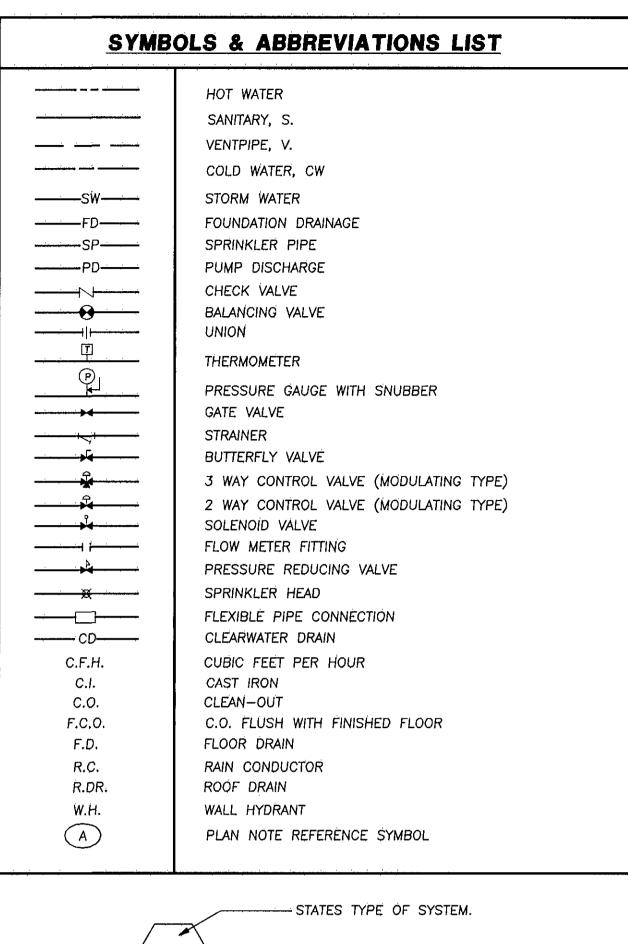

PLUMBING EQUIPMENT DESIGNATION


- STATES NUMBER OR LETTER CORRESPONDING TO RELATED SCHEDULE.

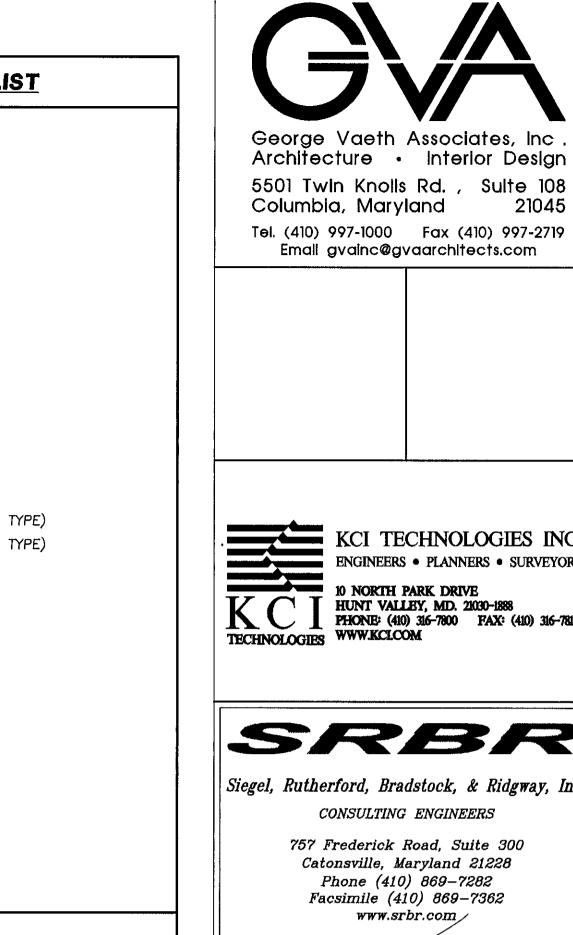





Phone (410) 869-7282 Facsimile (410) 869-7362 www.srbr.com/

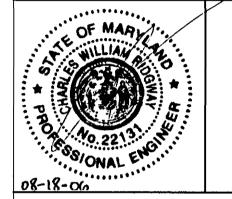

REVISIONS

NO. DATE DESCRIPTION

MAINTENANCE **FACILITY** ROCKBURN PARK **FOR** HOWARD COUNTY PARKS

NEW

& RECREATION PROJECT NUMBER: 0503 PRELIMINARY ISSUE: 09/29/05


CADD FILE NAME: PLUMBING SCHEDULE

CONSTRUCTION ISSUE:


SHEET NUMBER:

30 of 28

08/18/06

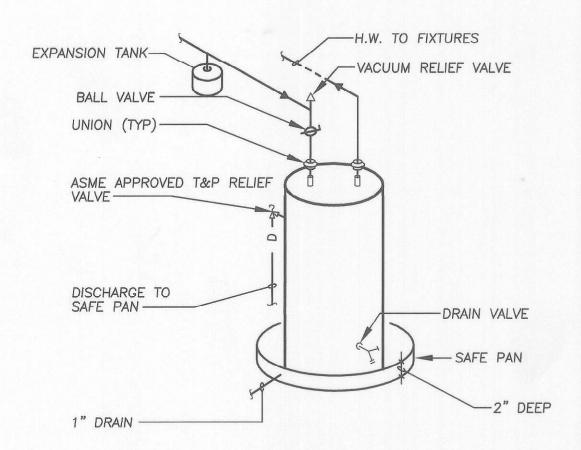


RESIDENTIAL ELECTRIC WATER HEATER PIPING DIAGRAM
NO SCALE

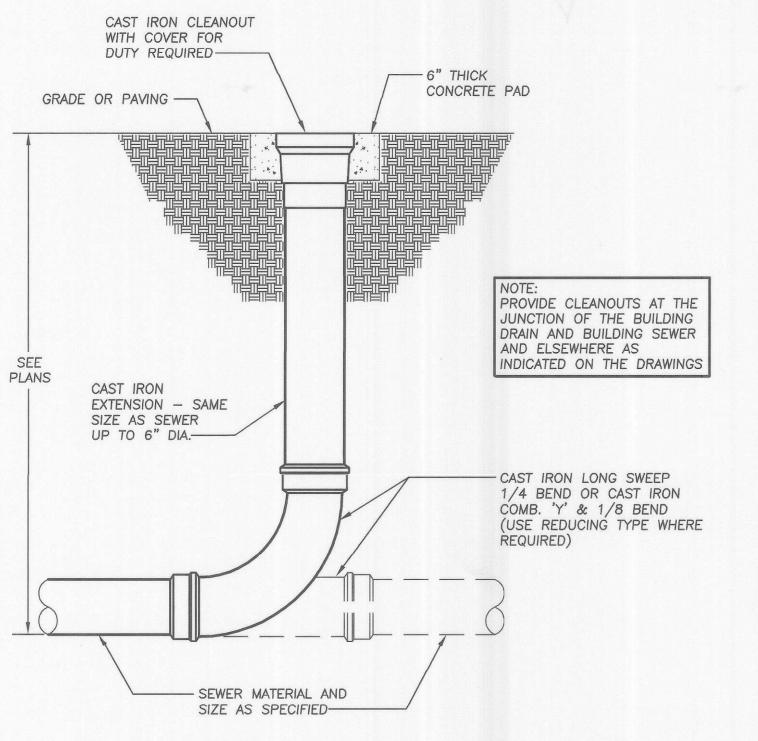


EXTERIOR CLEANOUT DETAIL

NO SCALE

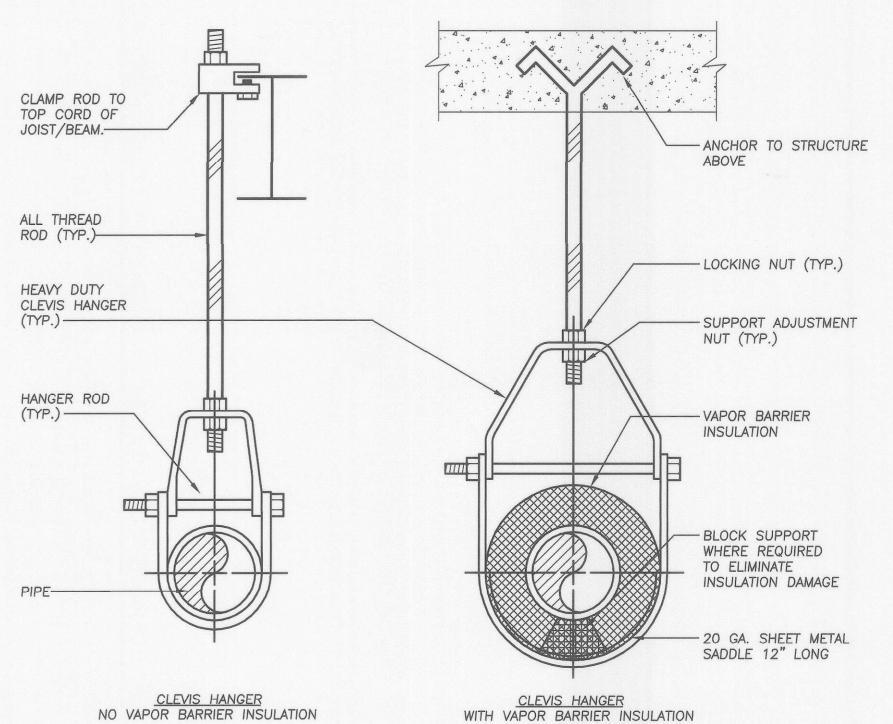


PIPE SUPPORT DETAIL

NO SCALE

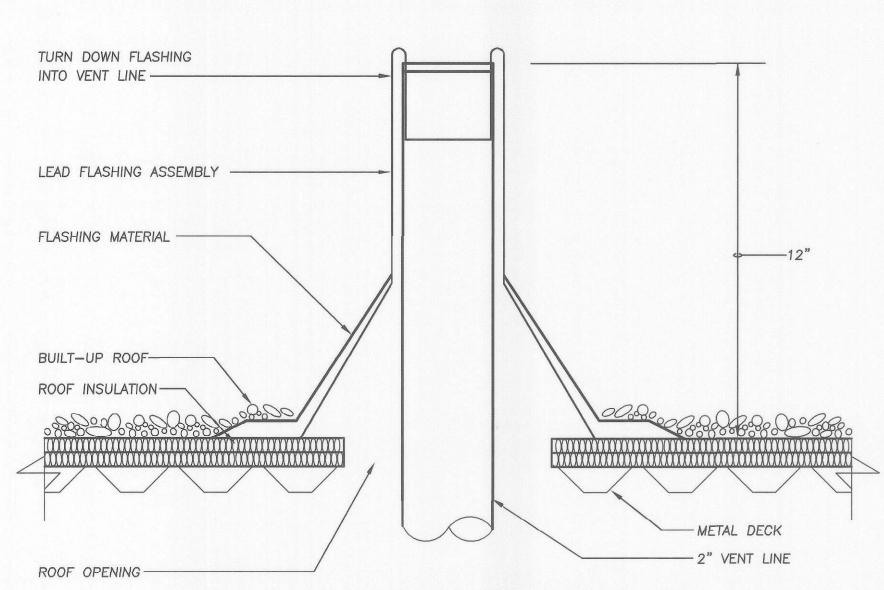

VENT PIPE THRU ROOF DETAIL

NO SCALE

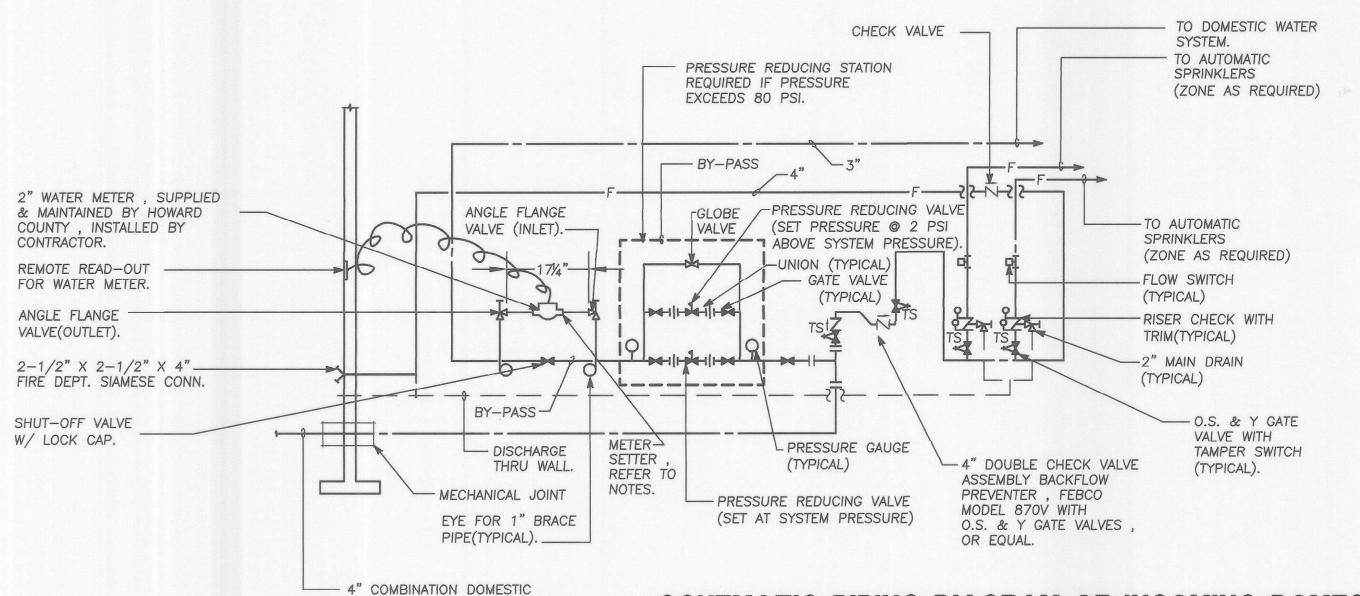

SCHEMATIC PIPING DIAGRAM OF INCOMING DOMESTIC WATER AND FIRE SERVICE

NO SCALE

WATER & FIRE SERVICE.

METER SETTER NOTES:

1.MINIMUM OF 6" REQUIRED BETWEEN WALL AND METER.
2.PROVIDE RIGID WALL AND/OR FLOOR BRACING TO
ACCOMODATE WEIGHT OF UTILIZING EYES
FOR BRACKETS.
3.METER SETTER SHALL BE ALL BRASS AND COPPER
WITH BY-PASS.
4.METER SETTERS:
A.FORD 2" #VV 77-15 HB-11-77
B.McDONALD 2" # 20-R-7-15-W W-FF-775

NEW
MAINTENANCE
FACILITY
ROCKBURN PARK
FOR

DESCRIPTION

REVISIONS

NO. DATE

George Vaeth Associates, Inc

Architecture • Interior Design

5501 Twin Knolls Rd., Suite 108

Tel. (410) 997-1000 Fax (410) 997-2719 Email gvalnc@gvaarchitects.com

KCI TECHNOLOGIES INC.

ENGINEERS • PLANNERS • SURVEYORS

10 NORTH PARK DRIVE HUNT VALLEY, MD. 21030-1888

TECHNOLOGIES WWW.KCLCOM

PHONE: (410) 316-7800 FAX: (410) 316-7817

SRBR

Siegel, Rutherford, Bradstock, & Ridgway, Inc.
CONSULTING ENGINEERS

757 Frederick Road, Suite 300

Catonsville, Maryland 21228
Phone (410) 869-7282
Facsimile (410) 869-7362
www.srbr.com

Columbia, Maryland

HOWARD COUNTY PARKS & RECREATION

PROJECT NUMBER: 0503

PRELIMINARY ISSUE: 09/29/05

CONSTRUCTION ISSUE: 08/18/06

PLUMBING DETAILS

SHEET NUMBER:

CADD FILE NAME:

CONSTRUCTION ISSUE 08/18/2006

P-3

PLUMBING SPECIFICATIONS

1. GENERAL

A. The GENERAL AND SPECIAL CONDITIONS shall govern this work as they apply.

2. SCOPE

- A. A. Plumbing work includes labor, materials and equipment, machinery and services necessary to provide complete plumbing system as hereinafter specified and shown on drawings, including layout of work and coordination of work with that specified elsewhere.
- B. Work includes, but is not limited to the following:
- 1. Plumbing work including fixtures, water, drainage, 2. waste, and piping vent.
- 3. All required temperature controls.

3. GENERAL REQUIREMENTS

- A. All work shall be in accordance with the requirements of the applicable Building and Plumbing Code and all other regulatory bodies or agencies having jurisdiction. All systems shall be complete. The Contractor shall do all excavation and back filling necessary to install underground piping included under this section.
- B. Contractor shall obtain and pay for all permits, licenses and inspections required under this section.
- C. The Contractor shall guarantee all materials and workmanship against defects for a period of one year after final acceptance of the work.
- D. Unless noted otherwise, all material shall be new and shall bear the Underwriter's Label where
- E. All work shall be subject to the requirements of all sections that may interlock with this section in any
- F. Electrical work performed under this Section shall comply with the requirements set forth under the "ELECTRICAL WORKS" Section. All motors -hp and over, shall generally be wound for 208-volt, 3-phase, 60-cycle current, unless otherwise noted.
- G. Provide all foundations and supports for equipment furnished under this section. Equipment mounted outside shall be placed on a 5" concrete pad. Rooftop equipment shall be mounted on roof curbs secured and flashed to roof.

4. COORDINATION OF TRADES:

- A. The Subcontractor shall give full cooperation to other trades and shall furnish in writing, with copies to the Architect, any information necessary to permit the work of the trades to be installed in proper sequence and with the least possible interference or
- B. If the Subcontractor install his work without coordinating with other trades, and the installation interferes with their installation, he shall make any changes necessary in this work to correct the condition without extra charge to the owner.
- C. If so directed by the Architect, the Subcontractor shall provide dimensioned fabrication drawings of critical areas, at not additional cost to the owner.

5. MATERIAL LIST AND SHOP DRAWINGS:

- A. Contractor shall submit a complete list of material and equipment for approval by Engineer with 30 days of contract date. The list shall describe type of material, capacities and catalog numbers of equipment, and give such information as necessary for checking equipment for approval.
- B. Contractor shall submit detailed shop drawings of all work and equipment for approval by the Architect and Engineer. Shop drawings shall give all pertinent information, and shall be properly checked and coordinated with other work before submission. No work shall be performed, save at Contractor's own risk, until applicable shop drawings and layout drawings have been approved. All substitute equipment shall be marked "substitute manufacturer".
- C. Any changes in any trade brought about by substitutions of specified equipment shall be done at no charge to the contract price and shall be fully coordinated with all other trades. The Contractor must indicate any and all cost credits associated with using substitute equipment.

6. PLUMBING FIXTURES:

- A. The Contractor shall provide all fixtures and trim necessary to complete the fixture installation. Approved stop valves to match fittings shall be provided on both hot and cold water supplies beneath each fixture. All fixtures requiring hot and cold water shall have cold water faucet at the right side and the hot water faucet at the left side of the fixture. All exposed metal work, including fixture run-outs shall be chromium plated. The color of all fixtures shall be white unless otherwise specified. Where fixture tailpieces and traps are not specified, these shall be provided to suit the fixture.
- B. Insulate all exposed drain and supply piping below handicap accessible fixtures per A.D.A. guidelines.

7. GUARANTEE AND SERVICE:

- A. Contractor shall avarantee all materials and workmanship for a period of one year after date of acceptance, and shall repair or replace, at no additional cost to the Owner, any part thereof which may become defective within guarantee period, ordinary wear and tear excepted. Contractor shall be responsible for and pay for any damages caused by or resulting from defects of his work.
- B. Contractor shall provide five-year warranty on all new compressor units.
- C. Contractor shall provide free service, inspection and adjustment of complete system and all necessary balancing and adjustments for one year beginning from the date of acceptance.

8. INSTRUCTIONS:

A. Contractor shall provide Owner with two copies of the instructions and maintenance charts, giving detailed information on operation and maintenance.

9. CLEANING OF EQUIPMENT AND WORK AREAS:

A. Upon completion, all equipment and work area shall be thoroughly cleaned, filters replaced with new. ready for use.

10. <u>PIPING:</u>

- A. Hot and cold piping shall be Type "L" copper, soldered lead-free solder. Isolating fittings shall be used to separate copper and steel piping.
- B. Soil, waste, drain and vent piping service weight cast iron below grade, galvanized steel, DWV copper or plastic above grade PVC plastic pipe may be used above arade where it meets fire rating requirements and is permitted by local code. No hub cast iron may be used for above ground systems.
- C. Special attention is directed to provide careful attention of water piping to prevent freezing. All such piping must be installed on the room side of insulation, making sure that the building insulation is continuous, fully protecting the entire length of
- D. Provide water hammer arrestors at all quick closing valves to prevent shock and vibration.
- E. Provide all hangers to properly support pipes. Hangers shall be clevis type. Multiple pipes may be hung on trapeze hangers. Provide sheet metal saddles under all insulated pipes.
- F. Fire stopping of piping is required at all fire rated penetrations and shall be of equal or greater value of the penetrated assembly.

11. <u>VALVES:</u>

A. Valves shall be brass or bronze suitable for 125-lb. working pressure for all services.

12. INSULATION FOR PIPING;

- A. All hot water and cold water mains, runouts and risers shall be insulated "thick Universal Fiberglass pipe covering. All fittings and valves must be insulated with "Zeston Jacket".
- B. "ARMAFLEX", as manufactured by Armstrong, is acceptable. Polyethylene and polyolefin products are not acceptable.

13. FIRE PROTECTION:

- A. The Contractor shall make all necessary modifications to existing fire sprinkler system based on new floor plan. The final system shall be in accordance with NFPA 13 - latest edition, and all local codes having jurisdiction.
- B. All piping shall be concealed wherever possible.

 Sprinkler heads shall be fast response type and shall be installed in accordance with manufacturer's recommendations and NFPA 13. Sprinkler heads shall be chrome plated, semi-recessed pendant type placed in center of ceiling tiles where possible, and straight-up right (or pendent if required) in areas with no suspended ceilings.
- C. Contractor shall prepare complete shop drawings indicating all new and existing pipe, heads, and valves. Shop drawings shall be drawn to scale. The Contractor shall also prepare detailed hydraulic calculations in accordance with NFPA 13 based on latest water flow data. Data shall not be more than 1-year old. Contractor shall obtain a new flow test if necessary. The shop drawings, calculations, and submitted data on all equipment and materials shall be submitted to the governing Fire Marshall's Office and Engineer for review.
- D. The final system shall be inspected and tested in accordance with the local jurisdiction requirements for final acceptance. The Contractor shall deliver certification of all tests and inspections to Architect
- E. It shall be the responsibility of the Contractor under this division to provide all devices, valves, electric wiring, etc., which may be required by the regulating agency or by the requirements under this section not provided by other divisions.

14. TRAP PRIMER:

A. Provide an automatic trap primer valve (one valve per trap, per floor drain) for each trap or floor drain. automatic primer valve shall hav integral vacume breaker, gasketed access cover, all bronze-polished chrome-plate an 3" union connection..Primer valve shall be installed per Manufacturer's recommendations. When installed on fixture in finished area, primer valve shall be concealed behind an access door with stainless steel or chrome-plated bronze frame and secured cover (vandal-proof) screws, 8"x8" minimum opening size, nickle bronze cover with polished top (or stainless steel). In lieu of primer valves, priming lines may be connected to slone VBF-72-A1 trap primer connection in flush valve tail piece.


Access Door

Josam Series No.58650 Zurn Series No. ZANB-1460-VP Wade Series No. W-8480-59-5 Jay R. Smith Series No. 4735

Trap Seal Primer Valve

Josam Series No. 88250 Zurn Series No. Z-1022 Wade Series No. W-2400 Jay R. Smith Series No. 2699


- B. Where indicated, or in lieu of primer valves specified above, provide an automatic trap priming station consisting of the following, or as approved by the Engineer.
- 1. Sloan Royal 186-ES Flush Valve with 1.5 gallon flow ring, #V-500-A vacuum breaker, #F-72 1" Female I.P.S. outlet, electric solenoid operater and 3" screwdriver-operated angle stop.
- 2. Electric timer arranged for one five-second operation every 24-hours.
- 3 One inch bronze manifold with outlets and integral screwdriver operated balancing fittings.
- 4. Surface mounted stainless steel cabinet with solid panel door.

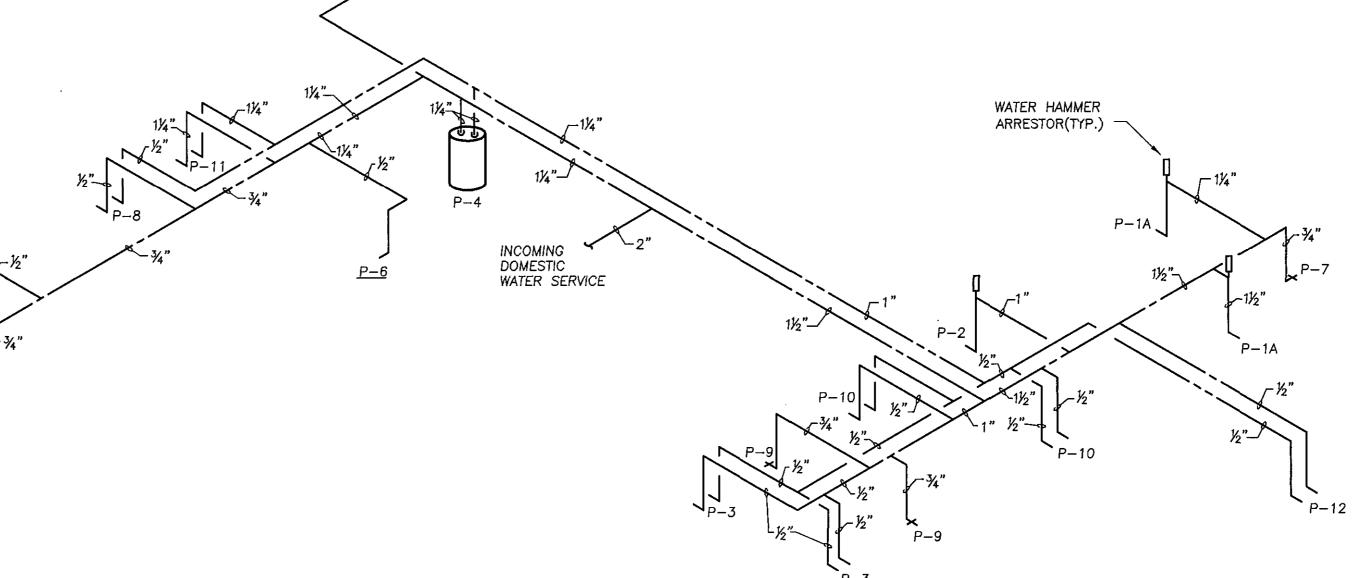

GAS RISER DIAGRAM

NO SCALE

DOMESTIC WATER RISER DIAGRAM

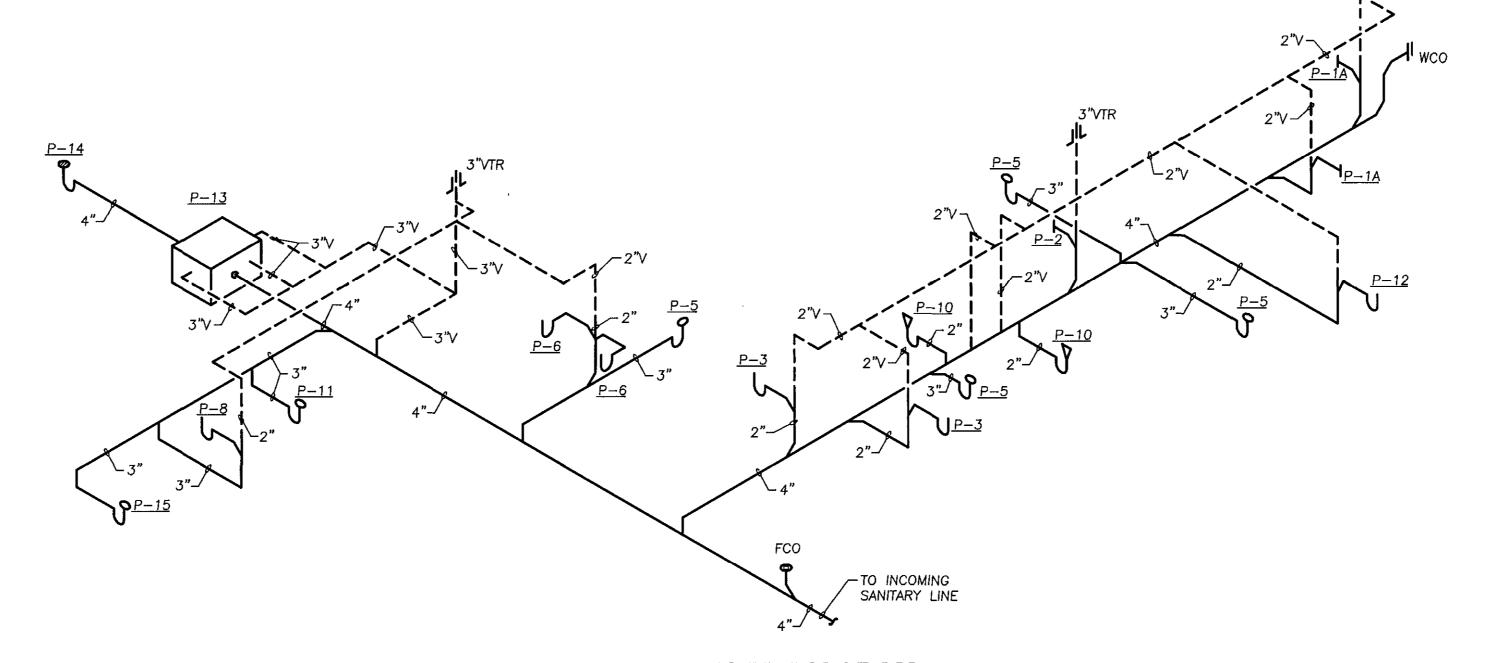

SANITARY RISER DIAGRAM

NO SCALE

CONSTRUCTION ISSUE 08/18/2006



George Vaeth Associates, Inc. Architecture • Interior Design 5501 Twin Knolls Rd., Suite 108 Columbia, Maryland Tel. (410) 997-1000 Fax (410) 997-2719 Emall gyalnc@gyaarchitects.com



-GAS METER TO HANDLE

EQUIVALENT LENGTH

480 CFH @ 120FT. PIPE

KCI TECHNOLOGIES INC. ENGINEERS • PLANNERS • SURVEYORS




10 NORTH PARK DRIVE HUNT VALLEY, MD. 21030-1888 PHONE: (410) 316-7800 FAX: (410) 316-7817



CONSULTING ENGINEERS

757 Frederick Road, Suite 300 Catonsville, Maryland 21228 Phone (410) 869-7282 Facsimile (410) 869-7362 www.srbr.com

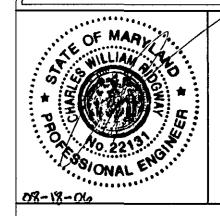

REVISIONS

NO. DATE DESCRIPTION

> NEW MAINTENANCE FACILITY **ROCKBURN PARK FOR**


HOWARD COUNTY PARKS & RECREATION

PROJECT NUMBER: 0503 PRELIMINARY ISSUE 09/29/05 CONSTRUCTION ISSUE: 08/18/06 CADD FILE NAME:

> PLUMBING **SPECIFICATIONS**

SHEET NUMBER:

320838

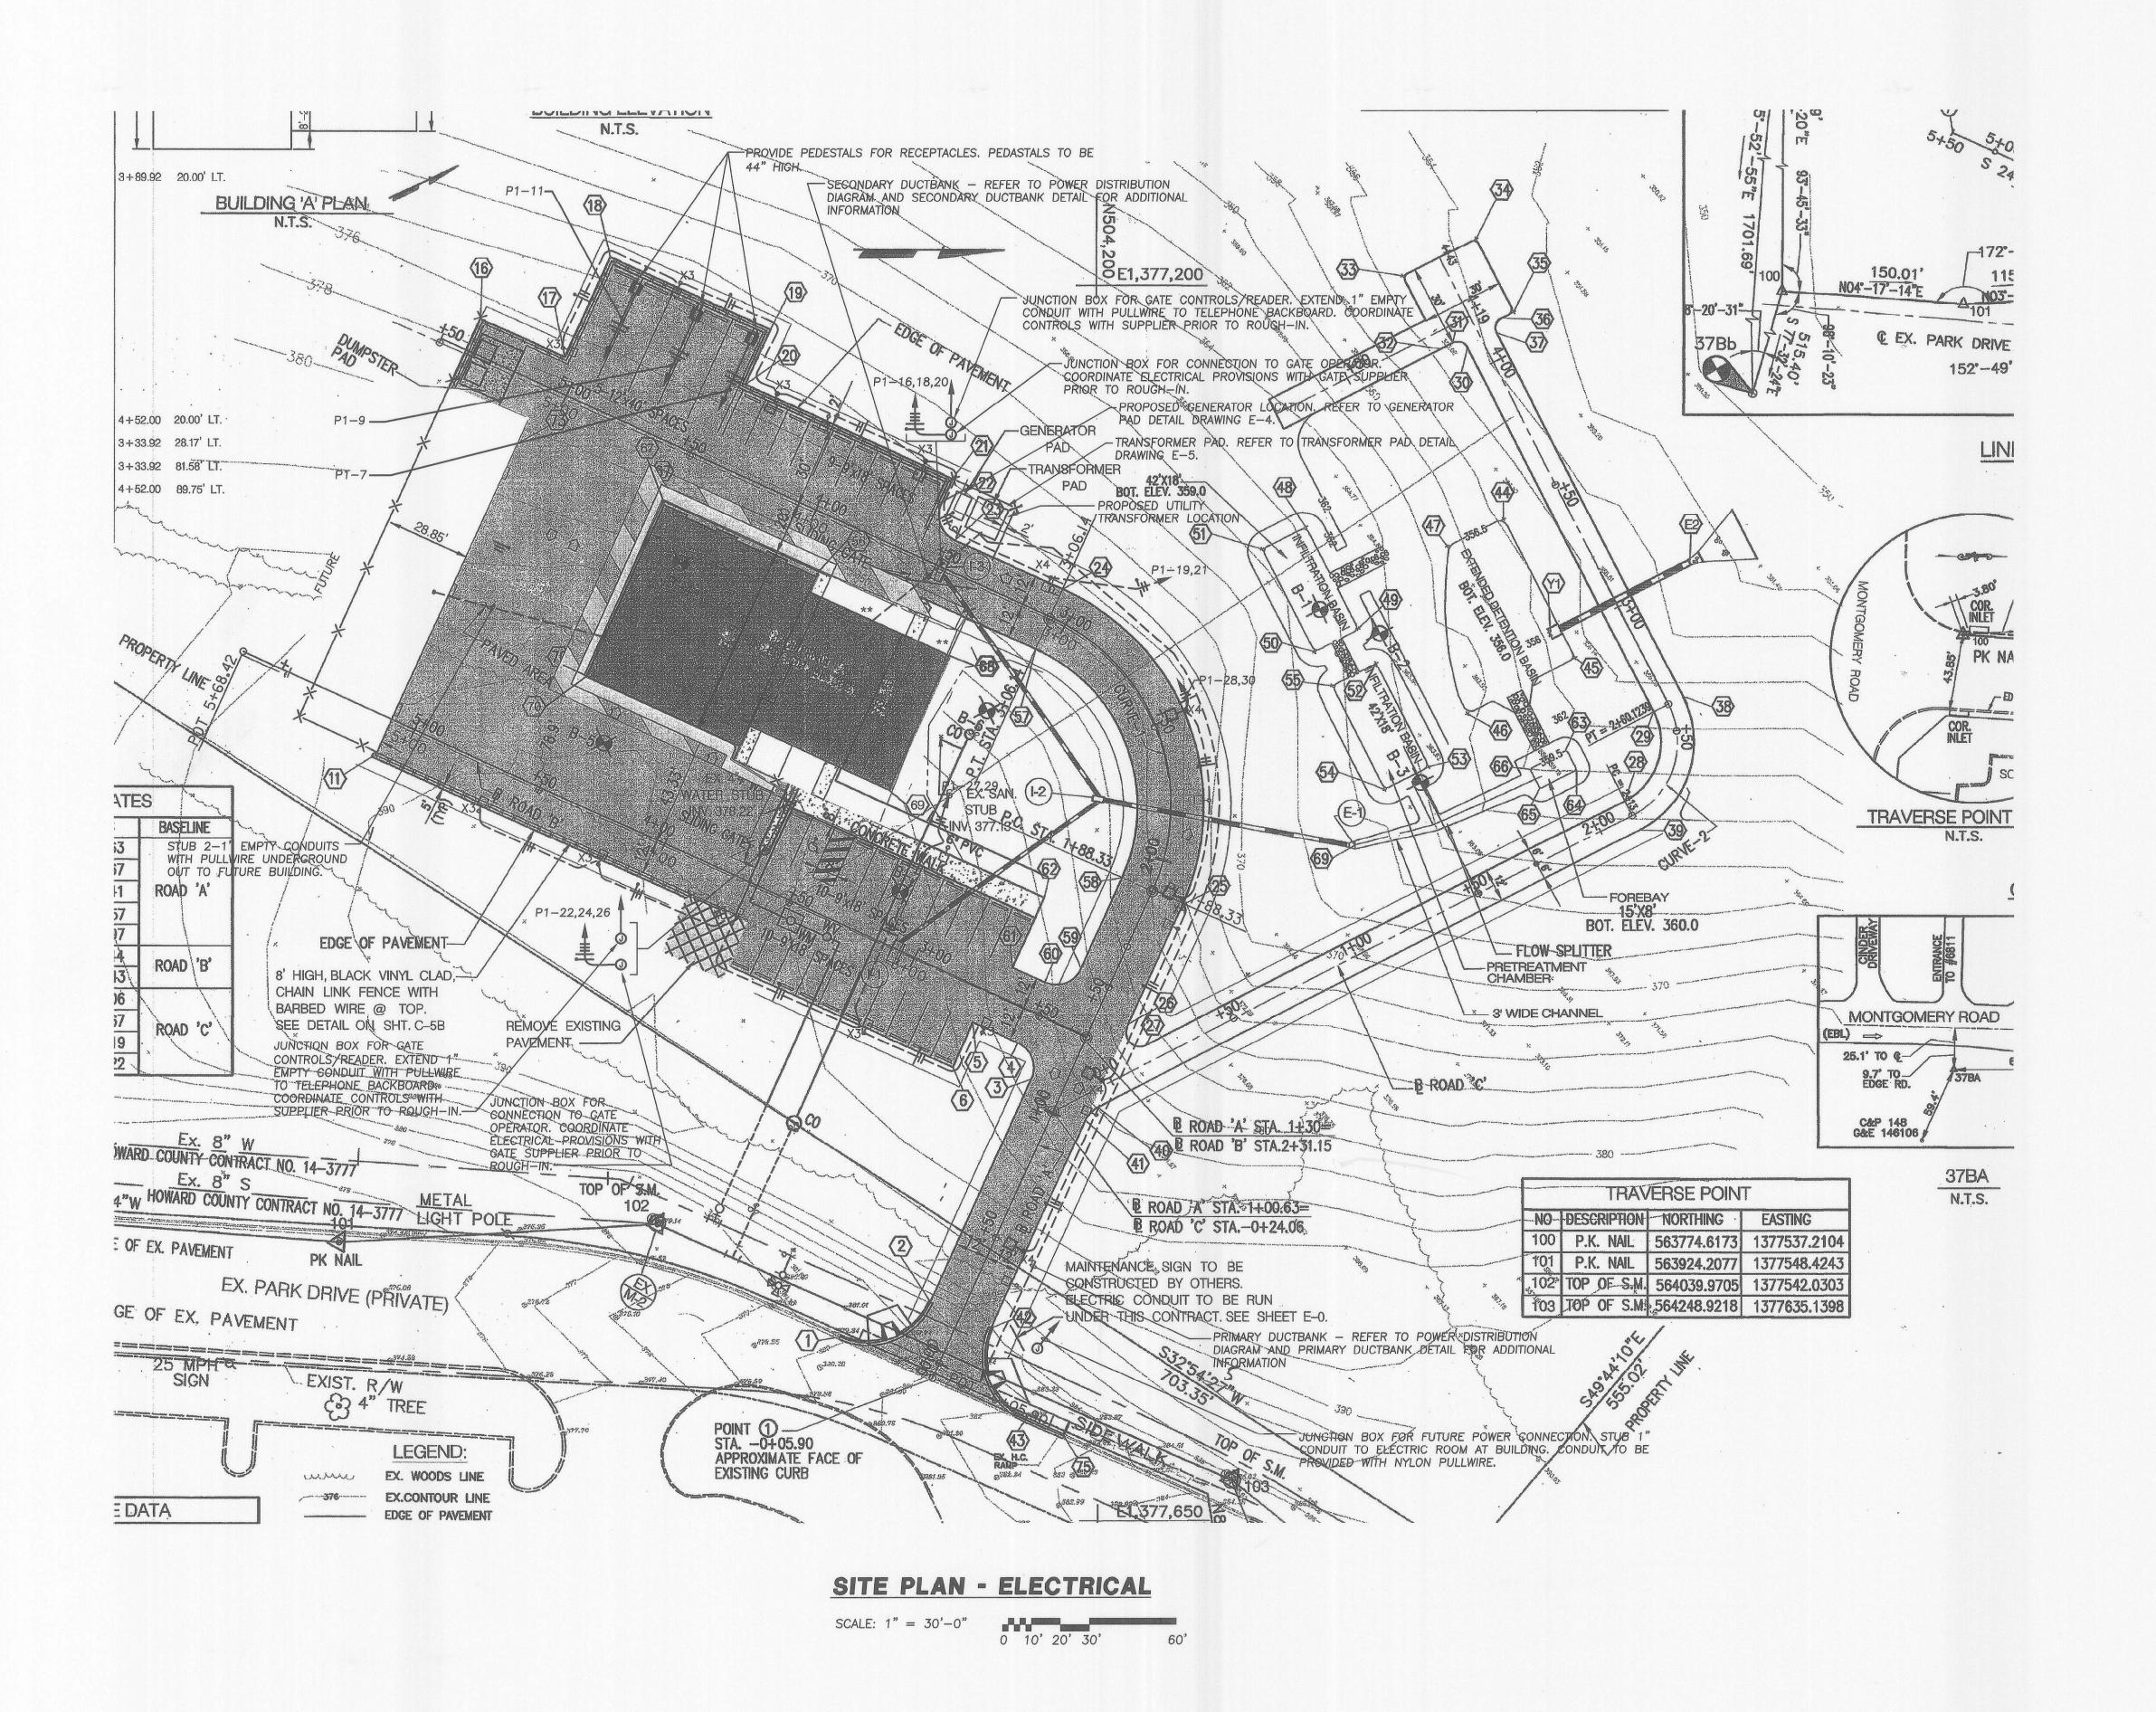

George Vaeth Associates, Inc

Architecture • Interior Design 5501 Twin Knolls Rd., Suite 108 Columbia, Maryland Tel. (410) 997-1000 Fax (410) 997-2719 Email gvainc@gvaarchitects.com

KCI TECHNOLOGIES INC. ENGINEERS • PLANNERS • SURVEYORS


10 NORTH PARK DRIVE HUNT VALLEY, MD. 21030-1888 PHONE: (410) 316-7800 FAX: (410) 316-7817 TECHNOLOGIES WWW.KCLCOM

SKBK

Siegel, Rutherford, Bradstock, & Ridgway, Inc. CONSULTING ENGINEERS

757 Frederick Road, Suite 300

Catonsville, Maryland 21228 Phone (410) 869-7282 Facsimile (410) 869-7362 www.srbr.com

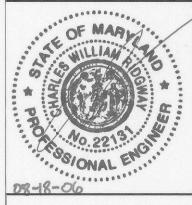

REVISIONS

NO. DATE DESCRIPTION


NEW MAINTENANCE FACILITY ROCKBURN PARK

HOWARD COUNTY PARKS & RECREATION

PROJECT NUMBER: 0503 09/29/05 PRELIMINARY ISSUE: CONSTRUCTION ISSUE: 08/18/06 CADD FILE NAME:

> SITE PLAN ELECTRICAL

SHEET NUMBER:

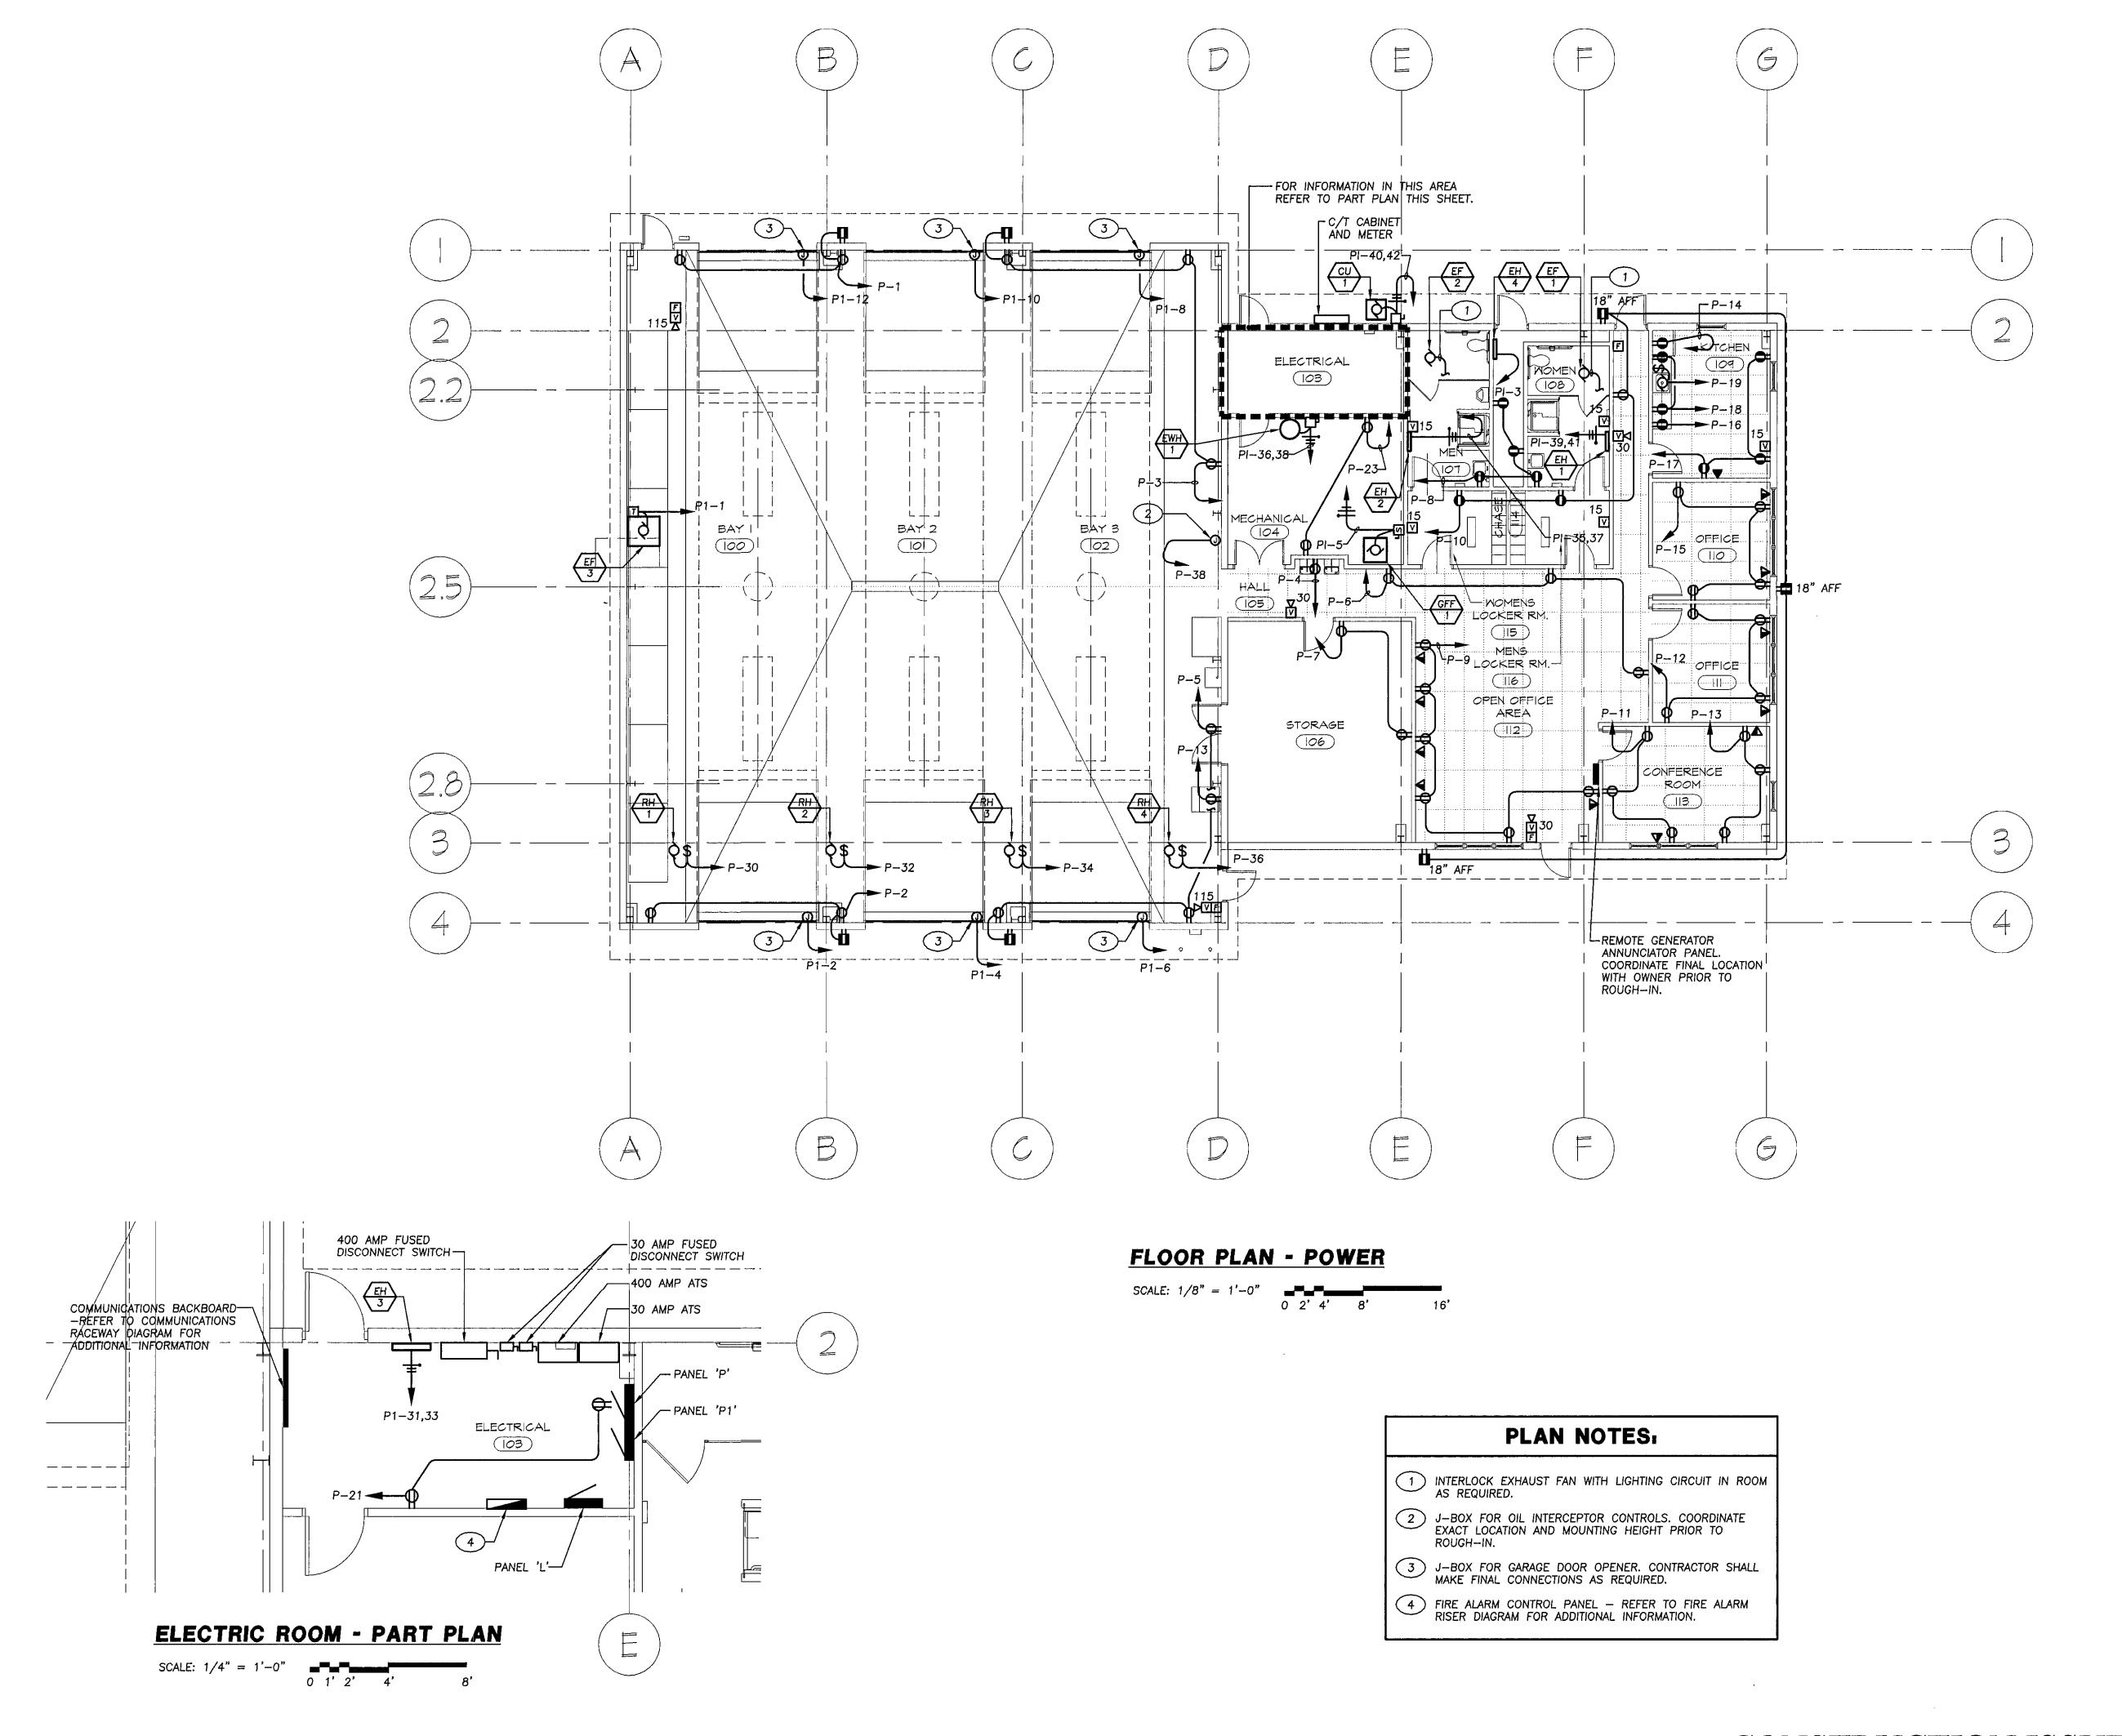

George Vaeth Associates, Inc. Architecture • Interior Design 5501 Twin Knolls Rd., Suite 108 Columbia, Maryland 21045 Tel. (410) 997-1000 Fax (410) 997-2719

Emall gvalnc@gvaarchitects.com

KCI H

KCI TECHNOLOGIES INC. ENGINEERS • PLANNERS • SURVEYORS

IO NORTH PARK DRIVE
HUNT VALLEY, MD. 21030-1888
PHONE: (410) 346-7800 FAX: (410) 346-7817
WWW.KCLCOM

SRBR

Siegel, Rutherford, Bradstock, & Ridgway, Inc.

CONSULTING ENGINEERS

757 Frederick Road, Suite 300 Catonsville, Maryland 21228 Phone (410) 869-7282 Facsimile (410) 869-7362 www.srbr.com



REVISIONS

NO. DATE DESCRIPTION

NEW
MAINTENANCE
FACILITY
ROCKBURN PARK

HOWARD COUNTY PARKS & RECREATION

PROJECT NUMBER: 0503

PRELIMINARY ISSUE: 09/29/05

CONSTRUCTION ISSUE: 08/18/06

CADD FILE NAME:


FLOOR PLAN POWER

SHEET NUMBER:

1111111

34 of 38

CONSTRUCTION ISSUE 08/18/2006

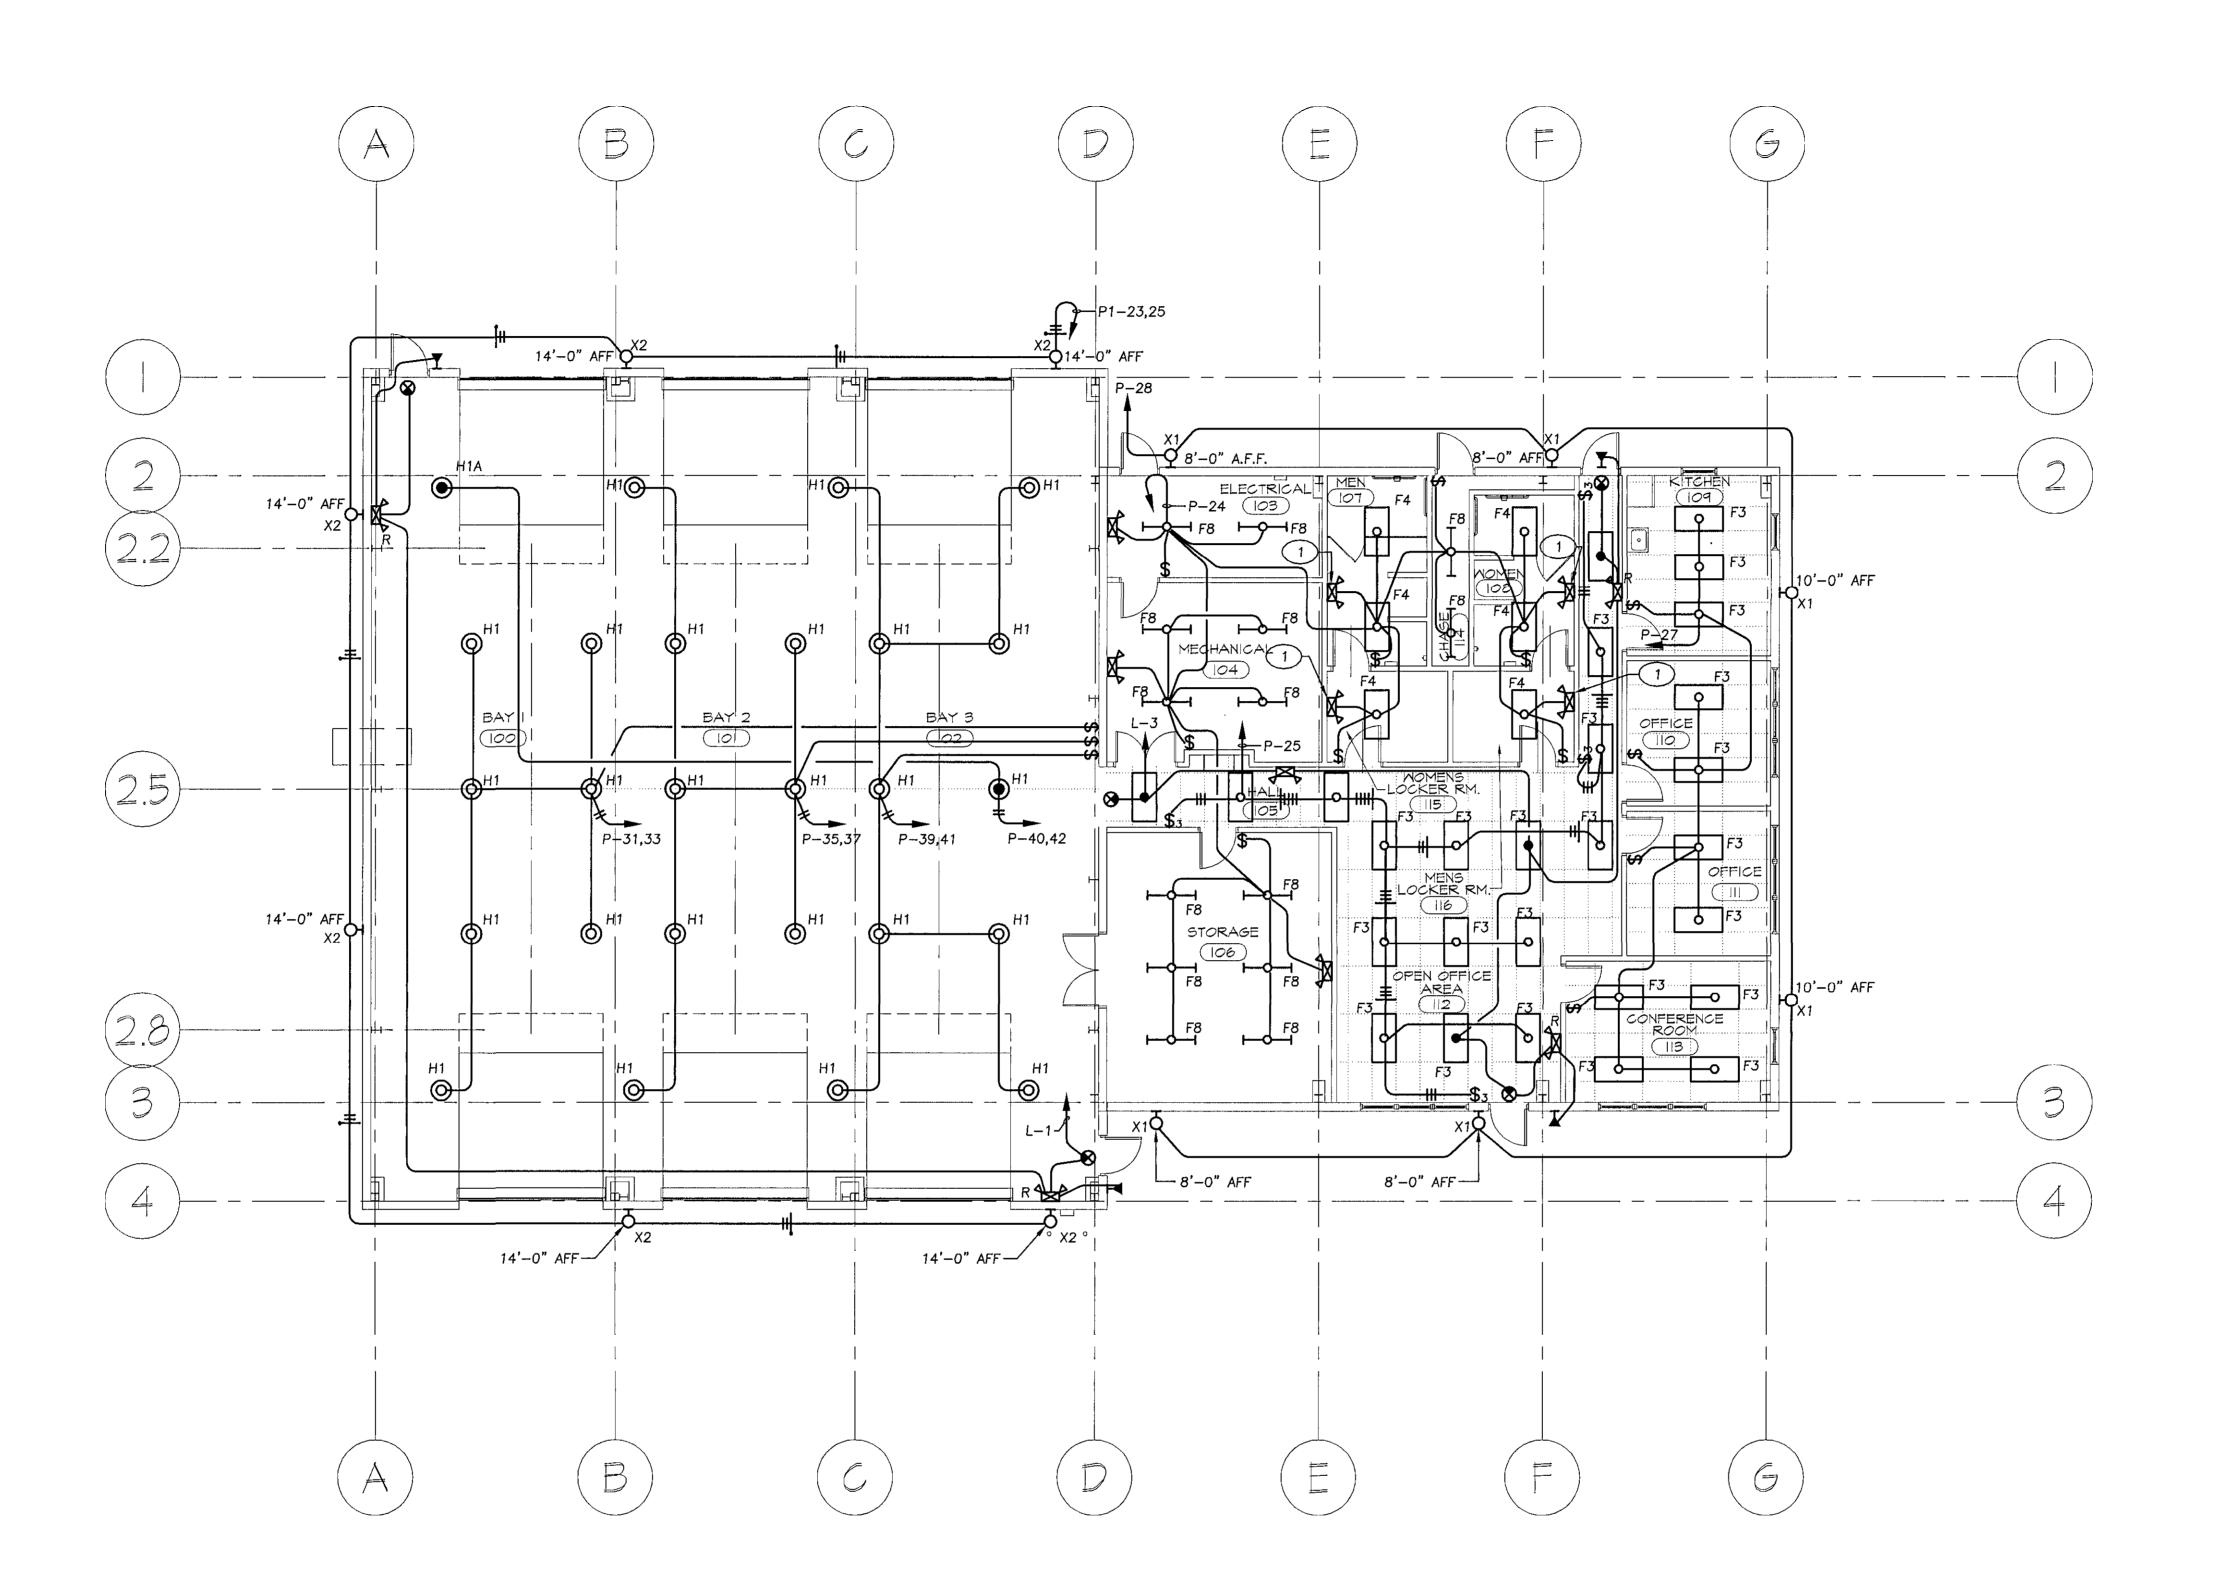

FLOOR PLAN - LIGHTING

SCALE: 1/8" = 1'-0" 0 2' 4' 8'

PLAN NOTES:

1 CONNECT EMERGENCY LIGHTING UNIT AHEAD OF LOCAL SWITCH.



George Vaeth Associates, Inc . Architecture • Interior Design 5501 Twin Knolls Rd., Suite 108 Columbia, Maryland Tel. (410) 997-1000 Fax (410) 997-2719 Email gvalnc@gvaarchitects.com


KCI TECHNOLOGIES INC. ENGINEERS • PLANNERS • SURVEYORS

IO NORTH PARK DRIVE
HUNT VALLEY, MD. 21030-1888
PHONE: (410) 316-7800 FAX: (410) 316-7817
WWW.KCLCOM

SRBR

Siegel, Rutherford, Bradstock, & Ridgway, Inc. CONSULTING ENGINEERS

> 757 Frederick Road, Suite 300 Catonsville, Maryland 21228 Phone (410) 869-7282 Facsimile (410) 869-7362 www.srbr.com

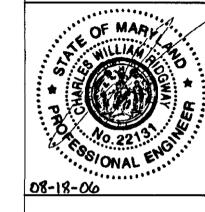

REVISIONS

NO. DATE DESCRIPTION

> NEW MAINTENANCE **FACILITY**

ROCKBURN PARK HOWARD COUNTY PARKS

& RECREATION PRELIMINARY ISSUE: 09/29/05


08/18/06

35 of 38

CONSTRUCTION ISSUE: CADD FILE NAME:

> FLOOR PLAN LIGHTING

SHEET NUMBER:

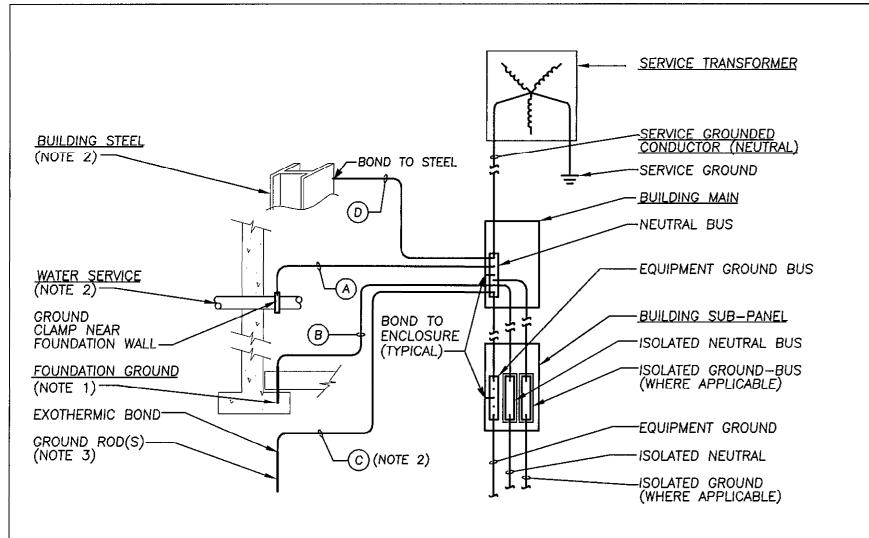

MAIN GROUNDING ELECTRODE DETAIL


NO SCALE

GROUNDING NOTES:

1. CONCRETE ENCASED ELECTRODE (SEE DETAIL).

- 2. IF CONTINUOUS METALLIC WATER PIPE OR BUILDING STEEL IS NOT AVAILABLE THEN GROUND ROD ELECTRODE SHALL BE FULL SIZE.
- 3. ADDITIONAL RODS SHALL BE ADDED AS NEEDED FOR TOTAL RESISTANCE OF 25 OHMS OR LESS.

GROUN	D CONDUCT	OR TAE	ILE	
SERVICE SIZE	A	В	С	D
100A	#8	#1	#6	#8
200A	#1	#4	#6	#4
400A	#1/0	#4	#6	#1/0
800A	#2/0	#4	#6	#2/0
OVER 800A	#3/0	#4	#6	#3/0
NOTES:	······································			
1. THE ABOVE CHART	GIVES MINIMUM	COPPER	GROUND	SIZES

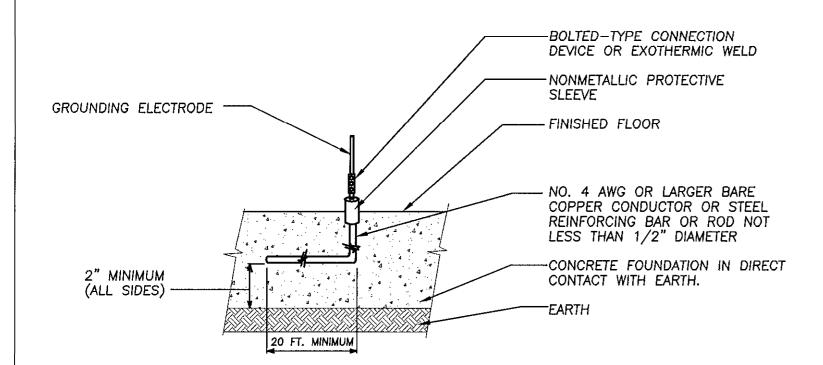


CONCRETE ENCASED ELECTRODE

NO SCALE


ELECTRODE NOTES:


1. CONCRETE ENCASED ELECTRODE SHALL BE IN ACCORDANCE WITH NATIONAL ELECTRIC CODE ARTICLE 250-50 (2) (C).

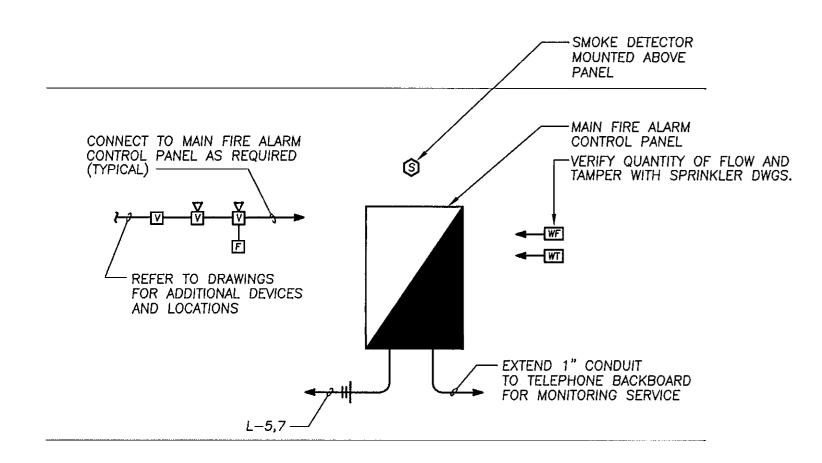

FIRE ALARM RISER DIAGRAM


NO SCALE

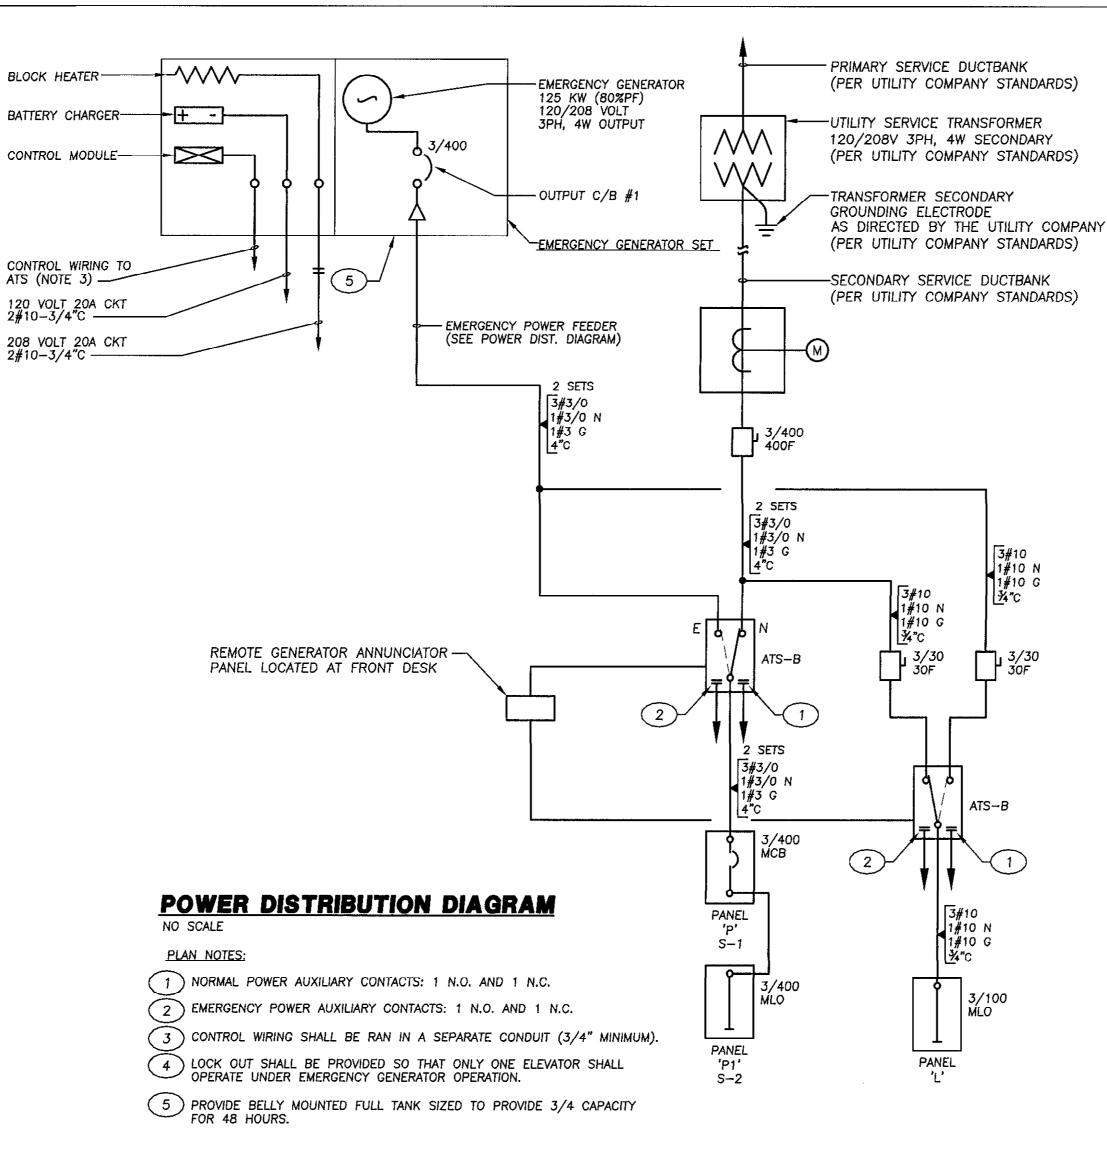

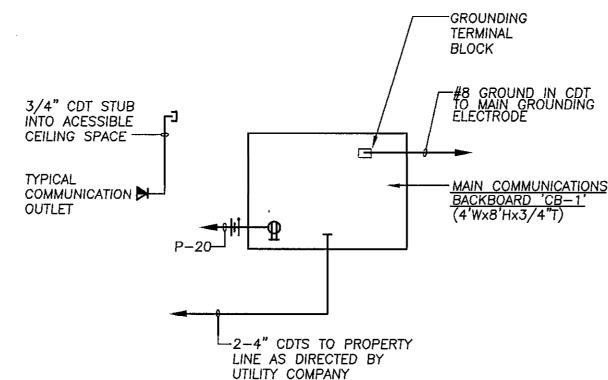

COMMUNICATION RACEWAY DIAGRAM

- 1. BACKBOARD SHALL BE FIRE TREATED PLYWOOD PAINTED MATTE WHITE.
- 2. PROVIDE 3/4" CONDUIT TO FIRE ALARM PANEL, SECURITY PANEL, ATC PANEL & ELEVATOR MACHINE ROOM (WHERE APPLICABLE).

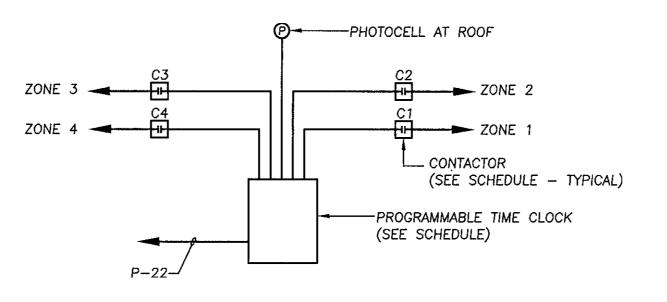

TIME CLOCK / CONTACTOR CONTROL DIAGRAM

MARK	SERVING	VOLT	ᄓᄱ	LOAD		IONS AT		CONTROL	NOTES
.		VOL1	111	LOAD	DEVICE	FRAME	FUSE	CONTROL	NOILS
RADIANT HEAT	ERS				-	I	ı	<u> </u>	
(RH)	RADIANT HEATER	120	1	1.4 AMPS	TSD		-	_	_
RH 2	RADIANT HEATER	120	1	1.4 AMPS	TSD	-	_		_
$\frac{RH}{3}$	RADIANT HEATER	120	1	1.4 AMPS	TSD	_	_		_
RH 4	RADIANT HEATER	120	1	1.4 AMPS	TSD	_	_		_
ELECTRIC HEA	TERS								
EH 1	ELECTRIC HEATER	208	1	2.0 KW	-	-	_	_	_
EH 2	ELECTRIC HEATER	208	1	2.0 KW	-	_	_		
EH 3	ELECTRIC HEATER	208	1	2.0 KW	_	1	_	_	
EH 4	ELECTRIC HEATER	120	1	0.5 KW	_		<u> </u>	_	
EXHAUST FANS	3								•
EF 1	EXHAUST FAN	120	1	83W		-	_	_	
EF 2	EXHAUST FAN	120	1	83W	1	_		_	_
EF 3	EXHAUST FAN	120	1	1/3 HP	TMS	_	_		_
GAS-FIRED FU	IRNACE								
GFF 1	GAS-FIRED FURNACE	120	1	3/4 HP	CFSS	30	20	_	_
AIR→COOLED (CONDENSING UNIT								
CU 1	AIR-COOLED CONDENSER	208	1	37.4 MCA	FSS	60	60	_	_
ELECTRIC WATI	ER HEATER								
EWH 1	ELECTRIC WATER HEATER	208	1	4.5 KW	FSS	30	30	_	
NOTES	UIPMENT INDICATED ABOVE IS F	FURNISHE	:D &	INSTALLED (JNDER ANG	OTHER DI	VISION (OF THE WOR	≺.

MECHANICAL EQUIPMENT CONNECTION SCHEDULE

2. ALL EXTERIOR SWITCHES AND SAFTEY SWITCHES TO BE NEMA 3R TYPE.

EQUIPMENT MARK

--EQUIPMENT TYPE

--- EQUIPMENT NUMBER

ATC - AUTOMATIC TEMPERATURE CONTROL (DIVISION 15) CFS - COMBINATION FUSED STARTER SAFETY SWITCH

FSS - FUSED SAFETY SWITCH NFSS - NON FUSED SAFETY SWITCH

MTS - MOTOR RATED TOGGLE SWITCH

TMS - THERMAL MANUAL MOTOR STARTER

TSD - TOGGLE SWITCH DISCONNECT WP - WEATHERPROOF

CONTACTOR CONTROL SCHEDULE								
MARK	LOAD DESCRIPTION	CIRCUITS CONTROLLED	POLES	RATING	CONTACTOR	LOCATION	CONTROL	REMARKS
C1	BUILDING LIGHTING			30A				
C2				30A				
C3				30A				
C4				30A				

- 1. CONTACTORS TO BE MECHANICALLY HELD TYPE ASCO #917 SERIES WITH PULSE MODULE OR APPROVED EQUIVALENT.
- 2. CONTACTORS TO BE HOUSED IN NEMA 1 WALL MOUNTED CABINET WITH HINGED LOUVERED DOOR, LOCATE CABINET ADJACENT TO LIGHTING PANEL.
- 3. PROVIDE 120 VOLT COIL POWER.
- 4. PROVIDE PROGRAMMABLE TIME CLOCK CONTROLLER (SEE DIAGRAM).

	PROGRAMMABLE	TIME CLOCK SCHEDULE
ZONE	DESCRIPTION	CONTROL
1	SECURITY LIGHTS	DUSK ON/ DAWN OFF
2	GENERAL EXTERIOR LTG	DUSK ON/ TIME CLOCK OFF
3	EXHAUST FANS	TIME CLOCK ON/OFF
4	SPARE	
NOTES:		

- 1. CLOCK SHALL BE PARAGON #EC74/120D SERIES OR APPROVED EQUIVALENT.
- 2. THE CLOCK SHALL HAVE THE FOLLOWING FEATURES: MEMORY BATTERY BACK-UP, 4 INDEPENDENT ON/OFF CHANNEL CONTROLS (ZONES), TIME OF DAY/365 DAY CALENDAR W/HOLIDAY PROGRAMMING, AUTOMATIC LEAP YEAR CORRECTION, AND PHOTOCELL INPUT FOR DUSK ON / DAWN OFF SIGNAL.
- 3. THE CONTRACTOR SHALL COORDINATE AND SET INITIAL CHANNEL CONTROL SETTINGS AS DIRECTED BY THE

George Vaeth Associates, Inc., Architecture • Interior Design 5501 Twin Knolls Rd., Suite 108 Columbia, Maryland Tel. (410) 997-1000 Fax (410) 997-2719 Email gvainc@gvaarchitects.com


PHONE: (410) 316-7800 FAX: (410) 316-7817 TECHNOLOGIES WWW.KCI.COM

KCI TECHNOLOGIES INC. ENGINEERS • PLANNERS • SURVEYORS 10 NORTH PARK DRIVE HUNT VALLEY, MD. 21030-1888

SRBR

Siegel, Rutherford, Bradstock, & Ridgway, Inc. CONSULTING ENGINEERS 757 Frederick Road, Suite 300

Catonsville, Maryland 21228 Phone (410) 869-7282 Facsimile (410) 869-7362 www.srbr.com

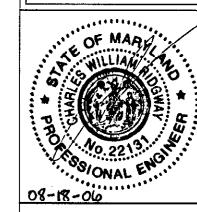

REVISIONS

NO. DATE DESCRIPTION

> **NEW** MAINTENANCE **FACILITY** ROCKBURN PARK

HOWARD COUNTY PARKS & RECREATION


PROJECT NUMBER: 0503 PRELIMINARY ISSUE: 09/29/05 CONSTRUCTION ISSUE: 08/18/06 CADD FILE NAME:

POWER DISTRIBUTION DIAGRAMS

SHEET NUMBER:

CONSTRUCTION ISSUE 08/18/2006

360#38

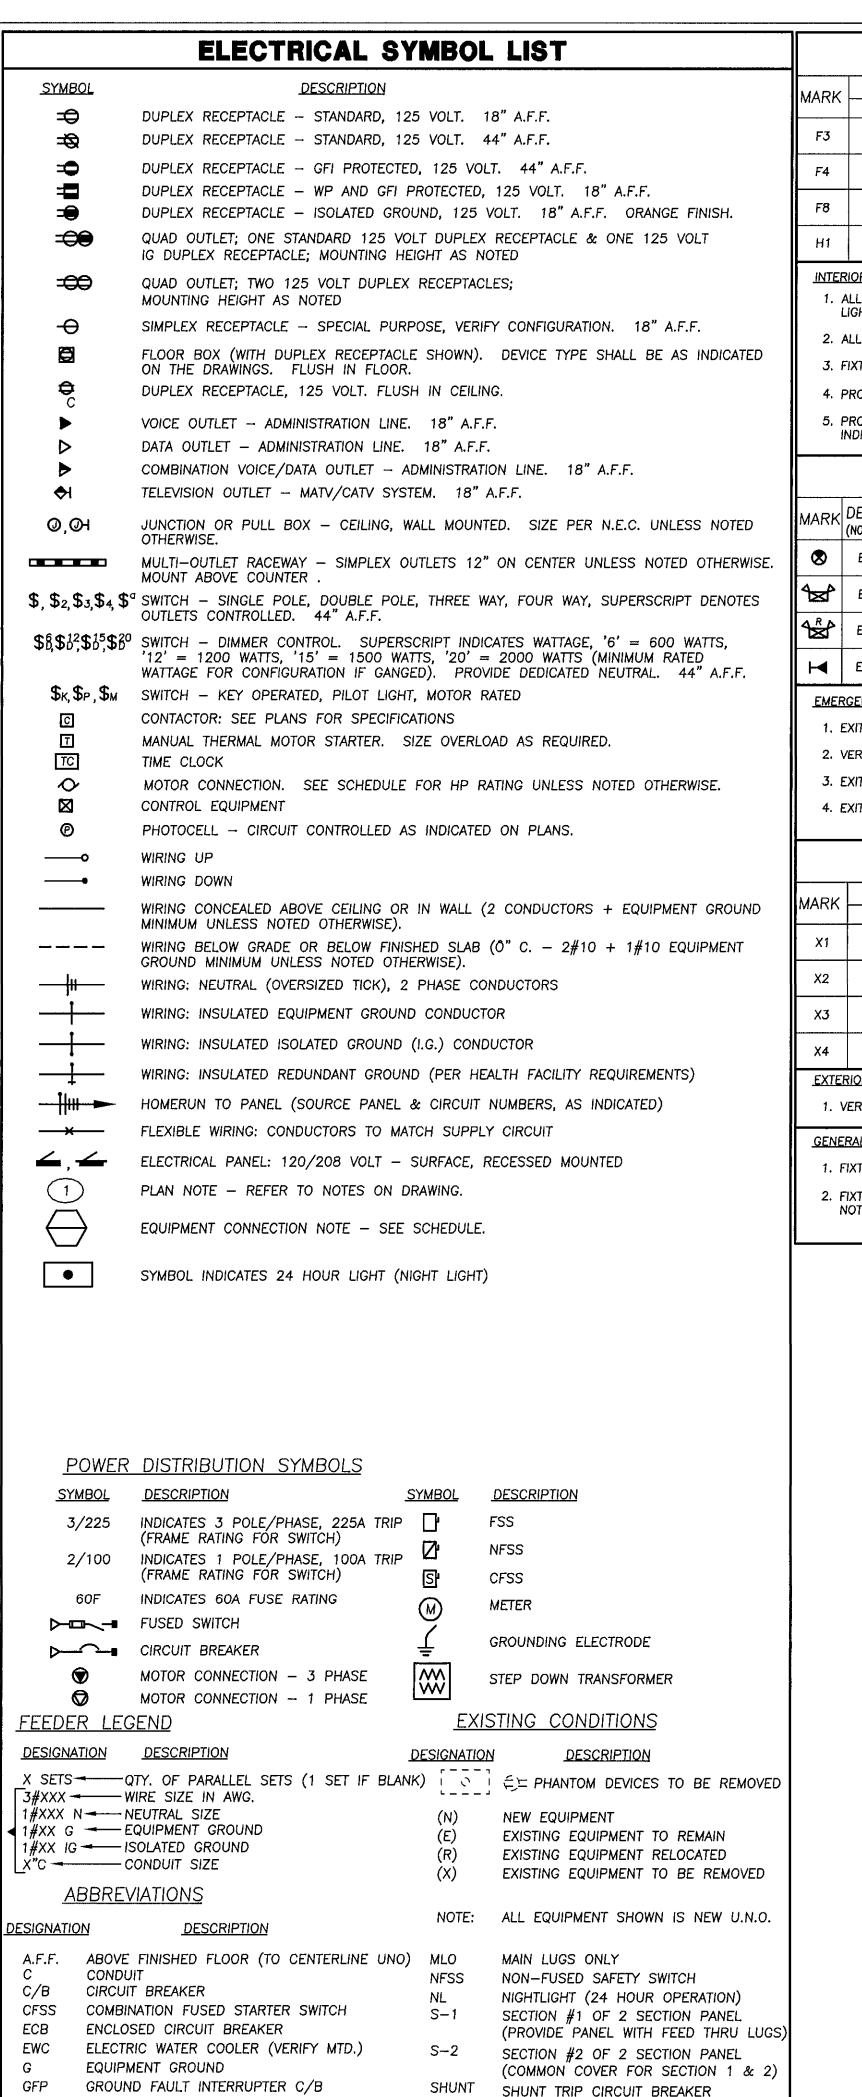

SURGE SUPPRESSOR

TRANSFORMER GROUND

UNLESS NOTED OTHERWISE

WEATHERPROOF (NEMA 3R UNO)

SUPER NEUTRAL

GROUND FAULT CIRCUIT INTERRUPTER

FUSED SAFETY SWITCH

MAIN CIRCUIT BREAKER

ISOLATED GROUND

FSS

				INTERIOR LIGHTI	NG	FIXTURE	_ (SCHE	DULE	
ARK	FIX	FIXTURE DESCRIPTION ILLUM TYPE DIFFUSER		REMARKS	VOLT	MOUNTING	l l	LAMPS	MANUFACTURER	TYPICAL
אתה	ILLUM			NEWARKS	VOLI	MOONTING	QTY	TYPE	MANUFACTURER	LOCATION
F3	FLUOR.	2' x 4'	.125 ACRYLIC PRISMATIC		120	GRID	3	F32 T8	DAYBRITE #2TG SERIES	
F4	FLUOR.	2' x 4'	.125 ACRYLIC PRISMATIC		120	RECESSED FLANGE	3	F32 T8	DAYBRITE #2TF SERIES	
F8	FLUOR.	4' STRIP		WIREGUARD	120	SURFACE/ SUSPENDED	2	F32 T8	DAYBRITE #T SERIES	UTILITY AREAS
Н1	HID	HIGH BAY	ACRYLIC REFRACTOR	FIXTURE PROVIDED WITH QUARTZ RESTRIKE	208	SUSPENDED	1	175W MH	GE #MGA-175MH-2-Q SERIES	

INTERIOR LIGHTING NOTES:

- 1. ALL T8 & COMPACT FLUORESCENT FIXTURES TO BE FURNISHED WITH ELECTRONIC BALLAST. PROVIDE MULTI-BALLASTS AND CONNECT FOR DUAL LEVEL LIGHTING WHERE INDICATED ON THE PLANS.
- 2. ALL T8 & COMPACT FLUORESCENT LAMPS TO BE 4100 K, 80 COLOR READERING INDEX + U.N.O.
- 3. FIXTURE SHALL BE CAPABLE OF OPERATING 26 WATT OR 32 WATT LAMPS.
- 4. PROVIDE QUANTITY OF 3' AND 4' STRIP LIGHTS REQUIRED FOR LENGTHS INDICATED ON THE PLANS.
- 5. PROVIDE TRACK IN LENGTHS INDICATED ON PLANS, ALONG WITH ALL REQUIRED MOUNTING AND CONNECTING HARDWARE. TRACK IS SUSPENDED WHERE INDICATED ON PLANS.

EMERGENCY LIGHTING FIXTURE SCHEDULE

MARK	DESIG.	FIXTUR	E DESC	RIPTION	REMARKS	VOLT	MOUNTING	l	LAMPS	MANUFACTURER	TYPICAL
INICITAL	(NOTE 3)	ILLUM	TYPE	SOURCE	NEMARKS	1021	141001411140	QTY	TYPE	WANDIACIONEN	LOCATION
⊗	EX1	LED	EXIT	INTEGRAL BATTERY	HIGH IMPACT THERMO WHITE PLASTIC HOUSING, SINGLE FACE	120	UNIVERSAL	_	FURNISHED W/ FIXTURE	EMERGI-LITE #EC SERIES	EXITS
1 ∞2	EB1	INCAND.	EMERG.	INTEGRAL BATTERY	TWIN HEAD, NO REMOTE	120	WALL	2	FURNISHED W/ FIXTURE	EMERGI-LITE #EC SERIES (12V, 12W HEADS)	
1 ₹	EB2	INCAND.	EMERG.	INTEGRAL BATTERY	TWIN HEAD, WITH REMOTE CAPABILITY	120	WALL			EMERGI-LITE #EC SERIES (12V, 12W HEADS)	
I	ER1	EMERG.	REMOTE HEAD	ADJUSTABLE EXTERIOR		120	UNIVERSAL			EMERGI-LITE #EF SERIES (12V, 12W HEADS)	

EMERGENCY LIGHTING NOTES:

- 1. EXIT SIGNS SHALL HAVE DIRECTIONAL ARROWS AS INDICATED ON THE PLANS.
- 2. VERIFY COLOR AND CONFIGURATION OF EXIT SIGN LETTERS WITH LOCAL CODES.
- 3. EXIT SIGNS AND EMERGENCY BATTERY PACKS ARE INDICATED BY SYMBOL ON THE PLANS IN LIEU OF LETTER DESIGNATION.
- 4. EXIT SIGNS AND EMERGENCY BATTERY PACKS SHALL BE CONNECTED AHEAD OF LOCAL SWITCH.


			[EXTERIOR LIGHTI	NG	FIXTUR	_ ;	SCHE	DULE		
MARK	FIXT	URE DESC	CRIPTION	REMARKS	VOLT	MOUNTING		AMPS	MANUFACTURER	TYPICAL	
1717 11 11 1	ILLUM	TYPE	FINISH	11211/11110			QTY	TYPE	W ITO TO TOTAL	LOCATION	Ш
X1	HID	WALLLIGHT	BRONZE	ARCHITECTURAL STYLE WIDE THROW DISTRIBUTION	120	SURFACE BLDG.	1	100 WATT M.H.	McPHILBEN #101 SERIES	_	
X2	HID	CUT-OFF	BRONZE	FORWARD DISTRIBUTION	208	SURFACE BLDG.	1	175 WATT Μ.Η.	GE LIGHTING #SPMM-17-MH-2-A-G		L
ХЗ	HID	CUT-OFF POLE	BRONZE	FORWARD THROW DISTRIBUTION	208	16' POLE	1	175 WATT M.H.	GE LIGHTING #DSM-17-MH-2-A-G		
X4	HID	CUT-OFF POLE	BRONZE	WIDE THROW DISTRIBUTION	208	16' POLE	1	175 WATT M.H.	GE LIGHTING #DSM-17-MH-2-A-G		


EXTERIOR LIGHTING NOTES:

1. VERIFY BASE OF LAMP WITH FIXTURE SUPPLIER.

GENERAL FIXTURE NOTES:

- 1. FIXTURE MARK IS TYPICAL FOR ALL FIXTURES OF THE SAME SYMBOL TYPE WITHIN THE SAME ROOM OR AREA U.N.O.
- 2. FIXTURE CATALOG # ESTABLISHES THE MANUFACTURER'S SERIES # COMPLETE CATALOG # SHALL BE DETERMINED BY THE SCHEDULE DESCRIPTION, PLAN NOTES, AND THE SPECIFICATIONS.

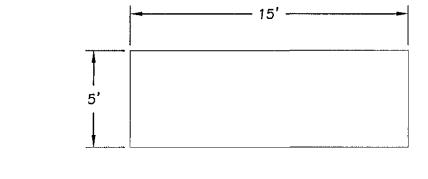

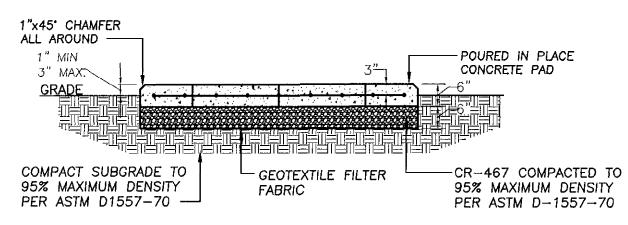

EMERGENCY GENERATOR PAD DETAIL

CONTRACTOR SHALL COORDINATE PAD SIZE WITH GENERATOR THAT IS TO BE PURCHASED PRIOR TO THE COMMENCEMENT OF WORK.



Emall gvalnc@gvaarchitects.com

TECHNOLOGIES WWW.KCLCOM


KCI TECHNOLOGIES INC. ENGINEERS • PLANNERS • SURVEYORS

10 NORTH PARK DRIVE HUNT VALLEY, MD. 21030-1888 PHONE (410) 316-7800 FAX: (410) 316-7817



Siegel, Rutherford, Bradstock, & Ridgway, Inc. CONSULTING ENGINEERS

> 757 Frederick Road, Suite 300 Catonsville, Maryland 21228 Phone (410) 869-7282 Facsimile (410) 869-7362 www.srbr.com

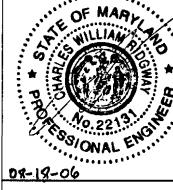

REVISIONS

NO. DATE DESCRIPTION

> **NEW** MAINTENANCE **FACILITY** ROCKBURN PARK


HOWARD COUNTY PARKS & RECREATION

PROJECT NUMBER: 0503 09/29/05 PRELIMINARY ISSUE: CONSTRUCTION ISSUE: 08/18/06 CADD FILE NAME:


SYMBOL LEGEND AND SPECIFICATIONS

SHEET NUMBER:

CONSTRUCTION ISSUE 08/18/2006

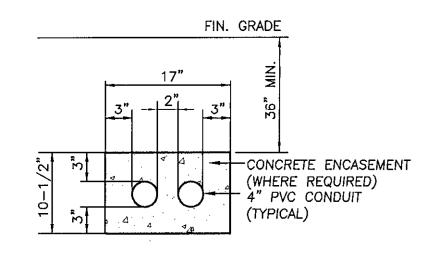

2 WAY PRIMARY DUCTBANK DETAIL NO SCALE

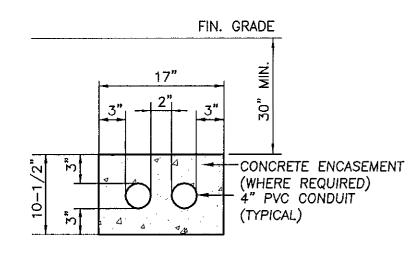

2 WAY SECONDARY DUCTBANK DETAIL


NO SCALE

- **DUCTBANK NOTES:** . PROVIDE DUCTBANK SPACERS EVERY 48" MINIMUM.
- 2. PROVIDE TEMPORARY ANCHORING TO PREVENT CONDUITS FROM FLOATING DURING
- 3. 2-WAY & 3-WAY DUCTBANKS REQUIRE CONCRETE ENCASEMENT ONLY AT 90 DEGREE BENDS, AT TRANSFORMER & BELOW PARKING LOTS/ROADWAYS.

16'

CONNECT #4 GROUND WIRE

TO GROUND LUG-

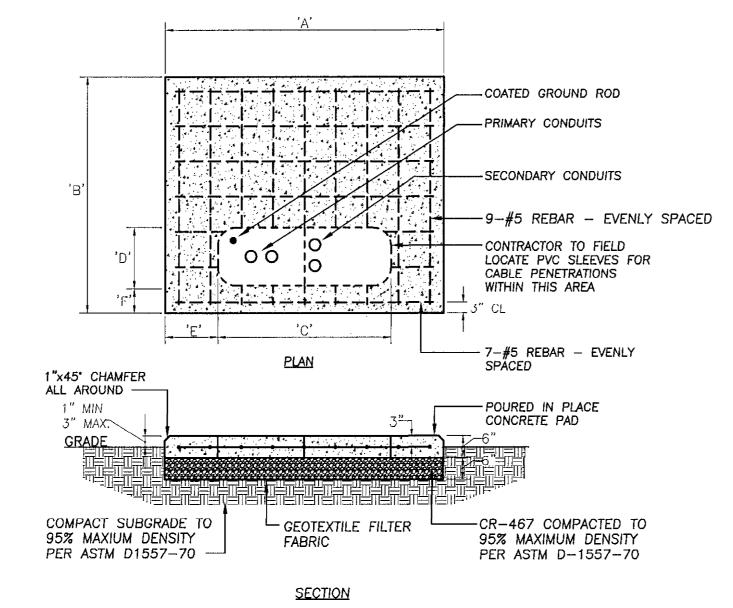

TRANSFORMER PAD DETAIL

RATING	Α	В	С	D	Ε	F
75-500 KVA	76"	66"	50"	18"	14"	6
NOTES: 1. VERIFY PAD I COMPANY. 2. PROVIDE SUM			•			

GENERAL NOTES:

LUMINAIRE (TWIN WHERE

ALUMINUM SQUARE POLE

DOUBLE NUTS WITH WASHERS GROUT WHEN LEVEL (TYPICAL

- 1"X 45" CHAMFER ALL AROUND

-PVC CONDUIT FEEDER 24"

3/4" X 10'-0" GROUND ROD

- ANCHOR BOLT (TYPICAL OF 4)

RE-BARS - 4#6 VERTICAL AND

#2 HORIZONTAL 12" ON CENTER

CONCRETE BASE

ÄLL AROUND

BELOW FINISH GRADE

#4 GROUND WIRE

- CAD WELD


WITH BRONZE ANODIZED

APPLICABLE)

HAND HOLE

OF 4 PLACES)

- DETAILS SHOWN ON THIS PLAN ARE INTENDED FOR REFERENCE, & GENERAL CONFORMANCE TO UTILITY COMPANY
- 2. UTILITY SERVICE WORK & MATERIALS USED TO BE IN STRICT

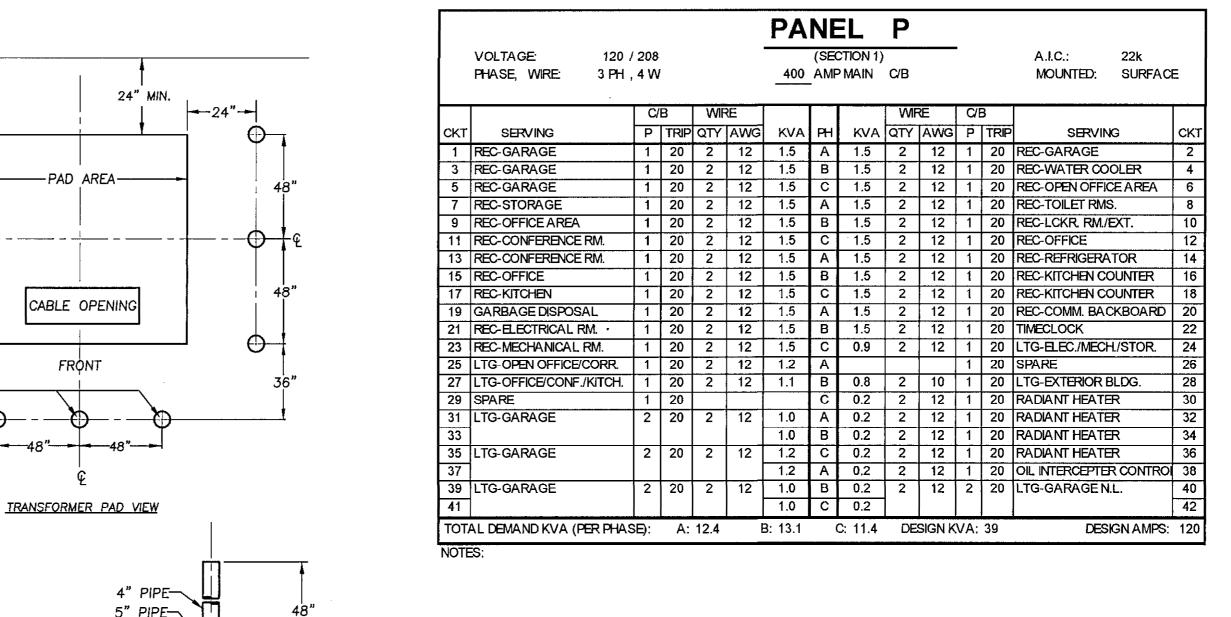

24"	24"				·			PA	NE	EL	P1	1	_			
12"	12"	E	VOLTAGE: 120 / PHASE, WIRE: 3 PH ,				,		(SEC	TION 2) MAIN		-	•		A.I.C.: 22k MOUNTED: SURFA	CE
ENTE OLIABO DIDEO	DEMONARIE ONARR	-		C	B	WIF	RE.				WIF	Œ	C/E	3	j	$\neg \neg \dashv$
FIXED GUARD PIPES	REMOVABLE GUARD PIPE ASSEMBLY	CKT	SERVING	Р	TRIP	QTY	AWG	KVA	PH	KVA	QTY	AWG	Р	TRIP	SERVING	СКТ
	THE ADDIMBET	1	EXHAUST FAN #3	1	20	2	12	0.9	Α	1.2	2	12	1		GARAGE DOOR	2
PARTS AND ACCESSORIES			ELECTRIC HEATER #4	1	20	2	12	0.5	В		2	12	1		GARAGE DOOR	4
PARTS AND	ACCESSURIES		GAS-FIRED FURNACE	1	20	2	12	1.8	С	1.2	2	12	1		GARAGE DOOR	6
			REC-TRUCK PARKING	1	20	2	12	1.5	A		2	12	1		GARAGE DOOR	8
DESCRIPTION	MATERIAL NUMBERS		REC-TRUCK PARKING REC-TRUCK PARKING	1 1	20	2	12	1.5 1.5	ВС	1.2	2	12	1	-	GARAGE DOOR GARAGE DOOR	10 12
			ICE MAKER	1	20	2	12	1.8	A	1.2	-	12	1		SPARE	14
1. GUARD PIPE	12-062		BUSSED SPACE	 -	20		12	1.0	В	0.6	4	12	3		SLIDING GATE	16
2. GUARD PIPE ASSEMBLY	12-167		BUSSED SPACE						C	0.6	1 .	'-		-	02151110 07112	18
			SITE LIGHTING	2	20	2	10	0.9	Α	0.6	1					20
NOTES:		21					li	0.9	В	0.6	4	12	3	20	SLIDING GATE	22
(A) TRAFFIC PROTECTION REQUIRED	WHEN TRANSFORMER IS INSTALLED	23	SITE LIGHTING	2	20	2	10	0.7	С	0.6						24
WITHIN 8' OF A ROADWAY OR P	PARKING LOT	25						0.7	Α	0.6						26
WITHIN O OF A NOADWAY ON E	ANNING LOT.		SITE LIGHTING	2	20	2	10	1.0	В	0.7	2	10	2	20	SITE LIGHTING	28
(B) 24" OF CLEARANCE MUST BE M	MAINTAINED AROUND EQUIPMENT. ALL DIMENSIONS	29		Ļ				1.0	С	0.7						30
SHOWN ARE MINIMUM AND ARE	NOT TO BE REDUCED. GAURD PIPES ARE		ELECTRIC HEATER #3	2	20	2	12	1.2	A	1.0	3	12	2		FIRE ALARM CONTROL	32
	THE VEHICLE WILL NOT COME INTO CONTACT	33	ELECTRIC HEATER #2	2	20	2	12	1.2	ВС	1.0 2.6	2	10	2		PANEL ELECTRIC WATER HEATER	34 R 36
	DOES NOT ALLOW, A MODIFIED TRAFFIC N BE SUPPLIED BY YOUR BGE REPRESENTATIVE.	35			20	-	'2	1.2	A	2.6	-	10	4	30		38
THO ZONON DONNION DAN	. DE GOTTELED DI TOUR DUE REPREDENTATIVE.		ELECTRIC HEATER #1	2	20	2	12	1.2	В	4.5	2	6	2	60	AIR COOLED CONDENSER	
(C) INSTALL REMOVABLE GUARD PIPI	ES IN FRONT OF EQUIPMENT DOORS ON FRONT	41		-		_		1.2	C	4.5	1 -		_			42
OF TRANSFORMER AS INDICATED	•		AL DEMAND KVA (PER PHAS	SE):	A:	11.7	<u></u>	3: 14.5		C: 16.0	DE	SIGN K	VA:	48	DESIGN AMPS	
		L		· · ·												

							PA	NE	EL	L						
	VOLTAGE: PHASE, WIRE:	120 / 3 PH ,				•	100 AMP MAIN LUG							A.I.C.: 10k MOUNTED: SURFA		Æ
		C/B		WIF	Œ				WRE		C/B					
СКТ	SERVING		Р	TRIP	QTY	AWG	KVA	PH	KVA	QTY	AWG	Р	TRIP	SER	RVING	CK
1	LTG-EMERGENCY *		1	20	2	12	0.2	Α				1	20	SPARE		2
3	LTG-EMERGENCY *		1	20	2	12	0.5	В				1	20	SPARE		4
5	FIRE ALARM		2	20	3	12	1.0	С				1	20	SPARE		6
7	CONTROL PANEL			ľ			1.0	Α						BUSSED SPA	/CE	8
9	BUSSED SPACE							В						BUSSED SPA	\CE	10
11	BUSSED SPACE							С						BUSSED SPA	CE	12
TOTA	AL DEMAND KVA (PE	RPHAS	E):	A:	1.3	E	3: 0.6	(C: 1.0	DE	SIGN K	VA:	4		DESIGN AMPS	: 11

* PROVIDE HANDLE LOCK-ON C/B COVER.

- ACCORDANCE WITH UTILITY COMPANY.
- CONTRACTOR SHALL INSTALL SYSTEM BASED ON THE FINAL UTILITY COMPANY ENGINEERING DRAWINGS.


TRAFFIC PROTECTION DETAIL

(D) INSTALL ALL GUARD PIPE BASES, BOTH STATIONARY AND REMOVABLE, IN

TWO (2) CU. FT. OF CONCRETE IS REQUIRED TO SET EACH BASE.

CONCRETE. FOR STATIONARY GUARD PIPES ONLY, FILL PIPES WITH CONCRETE.

NO SCALE

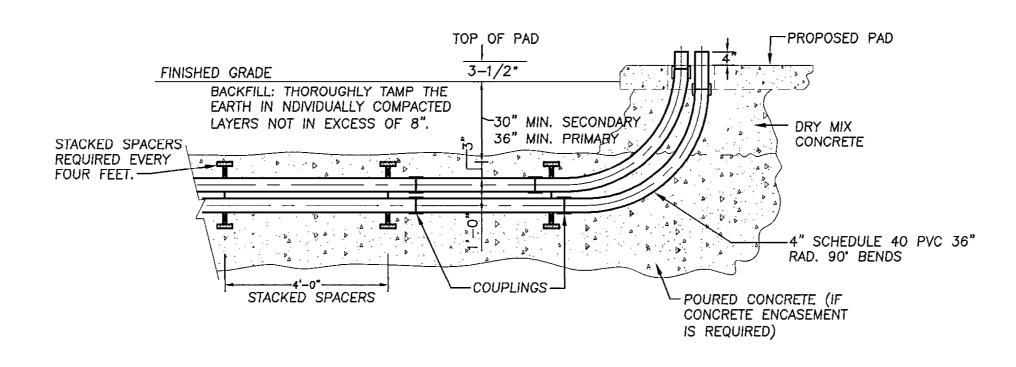

-24"-

REMOVABLE

GUARD PIPES-

FIXED GUARD PIPES

4" PIPE

FINAL GRADE-

TURNING CONDUITS INTO TRANSFORMER PADS

NO SCALE

POLE BASE DETAIL

NO SCALE

CONSTRUCTION ISSUE 08/18/2006

REVISIONS DESCRIPTION

George Vaeth Associates, Inc.,

Architecture • Interior Design

5501 Twin Knolls Rd., Suite 108

Tel. (410) 997-1000 Fax (410) 997-2719

Email gvalnc@gvaarchitects.com

KCI TECHNOLOGIES INC.

ENGINEERS • PLANNERS • SURVEYORS

10 NORTH PARK DRIVE

PHONE: (410) 316-7800 FAX: (410) 316-7817

SRBR

Siegel, Rutherford, Bradstock, & Ridgway, Inc. CONSULTING ENGINEERS

757 Frederick Road, Suite 300

Catonsville, Maryland 21228

Phone (410) 869-7282

Facsimile (410) 869-7362

www.srbr.com

TECHNOLOGIES WWW.KCLCOM

HUNT VALLEY, MD. 21030-1888

Columbia, Maryland

MAINTENANCE **FACILITY ROCKBURN PARK**

NEW

HOWARD COUNTY PARKS & RECREATION

PROJECT NUMBER: 0503 09/29/05 PRELIMINARY ISSUE: CONSTRUCTION ISSUE: 08/18/06 CADD FILE NAME:

PANELBOARD SCHEDULES

SHEET NUMBER:

NO. DATE

380F38